

# Ministry of Public Works Department of Works and Engineering

**Request for Proposals** 

For

**Asphalt Plant Site Works** 

ADDENDUM 1

Request for Proposals No.: PN/2024-002-Q-AP

Issued: Friday July 26, 2024

Submission Deadline: Friday September 6, 2024 03:00:00 PM Bermuda Local Time

#### **ADDENDUM 1**

1. The following RFP Timetable has been revised per the request of the potential bidders.

#### **Key Dates**

Issue Date of RFP	Friday July 26, 2024
Pre-Bid / Site Meeting	Tuesday August 13, 2024 11:00 AM
Deadline for Questions	Friday August 30, 2024
Deadline for Issuing Addenda	Wednesday September 4, 2024
Submission Deadline	Friday September 6, 2024 03:00:00 PM
Rectification Period	5 business days
Anticipated Ranking of Proponents	Friday September 20, 2024
Contract Negotiation Period	30 calendar days
Anticipated Execution of Agreement	Friday October 11, 2024

All times listed are Bermuda local time. The RFP timetable is tentative only and may be changed by the Government at any time. For greater clarity, business days means all days that the Government is open for business.

- 2. Scope of Work The Owner shall not supply any materials shown on the drawings, i.e. reinforcing steel, anchor bolts, embeds, etc. required by the Proponent to complete the Works as detailed on the drawings.
- 3. Please refer to the attached 26 drawings for changes and extra details of the Works.
- 4. Please note that the design continues to be defined and another addenda should be expected.

#### 1.0 GENERAL

- 1.1 THESE NOTES APPLY TO ALL STRUCTURAL DRAWINGS AND ARE TO BE READ IN CONJUNCTION WITH THE CONTRACT DOCUMENTS AND SPECIFICATIONS.
- 1.2 DO NOT SCALE THE DRAWINGS. DIMENSIONS ARE TO BE USED AS A GUIDE ONLY.
- 1.3 ALL DETAILS AND ARRANGEMENTS OF EXISTING CONDITIONS, DIMENSIONS, ETC. TO BE FIELD VERIFIED PRIOR TO CONSTRUCTION. ANY DISCREPANCIES SHALL BE BROUGHT TO THE ENGINEER'S ATTENTION.
- 1.4 CONTRACTOR TO MAKE GOOD ANY DAMAGES CAUSED ON SITE, REPAIRING TO MATCH EXISTING OR AS APPROVED BY THE OWNER.
- 1.5 THE CONTRACTOR SHALL SUPPLY ALL NECESSARY MATERIALS, EQUIPMENT AND LABOR TO COMPLETE THE WORK, UNLESS OTHERWISE INDICATED.
- 1.6 THE CONTRACTOR SHALL PROVIDE COMPETENT SUPERVISORY STAFF AT ALL TIMES DURING THE WORK. TRADESMEN ARE TO BE SKILLED AND QUALIFIED FOR THE TASKS ASSIGNED.CONTRACTOR SHALL SUPPLY ALL NECESSARY MATERIALS, EQUIPMENT AND LABOR TO COMPLETE THE WORK, UNLESS OTHERWISE INDICATED.
- 1.7 THE CONTRACTOR SHALL PROVIDE ALL SAFETY EQUIPMENT AND GEAR TO CONFORM TO THE NATIONAL HEALTH AND SAFETY REGULATIONS APPLICABLE TO BERMUDA.
- 1.8 THE CONTRACTOR SHALL VERIFY ALL SITE CONDITIONS AND FAMILIARIZE THEMSELVES WITH THE SCOPE OF WORK.
- 1.9 ALL CONSTRUCTION OPERATIONS ARE TO COMPLY WITH THE MINIMUM REQUIREMENTS OF THE BERMUDA RESIDENTIAL BUILDING CODE 2014.

#### 2.0 CONCRETE

- 2.1 STRUCTURAL CONCRETE STRENGTH TO BE A MINIMUM OF 30 MPa (4350 PSI).
- 2.2 CONCRETE BLINDING/LEAN MIX BUILD UP STRENGTH MUST BE A MINIMUM OF 14MPa (2000 PSI).
- 2.3 REINFORCING CHAIRS TO BE PLASTIC, OR CONCRETE.
- 2.4 NO ADDITIVES TO BE USED WITHOUT THE PRIOR APPROVAL OF THE ENGINEER. NO WATER SHALL BE ADDED TO THE MIX ON SITE WITHOUT THE PRIOR APPROVAL OF THE ENGINEER.
- 2.5 THE CONTRACTOR SHALL GIVE A MINIMUM OF 48 HOURS NOTICE TO THE ENGINEER PRIOR TO POURING ANY CONCRETE.
- 2.6 CONCRETE COVER TO BE 3" FOR CONCRETE CAST AGAINST AND PERMANENTLY EXPOSED TO EARTH (E.G. RETAINING WALLS AND FOUNDATIONS), 2" FOR CONCRETE EXPOSED TO WEATHER AND 1.5" FOR CONCRETE NOT EXPOSED TO WEATHER OR EARTH U.N.O
- 2.7 CONCRETE IS TO CURE FOR 7 DAYS MINIMUM PRIOR TO LOADING U.N.O.
- 2.8 EXPERIENCED PERSONNEL SHALL MECHANICALLY VIBRATE ALL STRUCTURAL CONCRETE IN THE APPROVED MANNER. THE CONTRACTOR SHALL HAVE AT LEAST TWO FULLY OPERATIONAL POKER VIBRATORS ON SITE DURING CONCRETE PLACEMENT.
- 2.9 ALL FORMWORK, SHORING AND RESHORING SHALL BE DESIGNED BY THE CONTRACTOR'S REGISTERED ENGINEER.
- 2.10 FOUNDATIONS, WALLS, SLABS, BEAMS AND GIRDERS SHALL NOT HAVE JOINTS IN A HORIZONTAL PLANE UNLESS SHOWN OTHERWISE.
- 2.11 CONCRETE SLUMP TO BE AS FOLLOWS:

  BEAMS/FOOTINGS/COLUMNS AND SLABS = 5" +/- 1"

  MASONRY BLOCK FILL = 7" +/- 1"
- 2.12 CONCRETE BEAMS TO HAVE A MINIMUM BEARING OF 8" ON EACH SIDE ONTO SOLID CONCRETE OR FILLED MASONRY BLOCK (WALL STIFFENER/WS) WITH A MINIMUM WIDTH OF THE RESPECTIVE BEAM U.N.O.

#### 3.0 REINFORCING STEEL

- 3.1 REINFORCING STEEL SHALL HAVE A MINIMUM STRENGTH OF 400 MPa (OR APPROVED EQUAL).
- 3.2 REINFORCING STEEL TO BE GALVANISED IN ACCORDANCE CLASS II STANDARD ASTM A767.

- 3.3 REBAR AT ENDS OF CONCRETE LINTELS, WALL STIFFENERS, COLUMNS, STAIRS, PAD FOOTINGS, BEAMS AND SLABS ARE TO HAVE STANDARD 90° BENDS WITH THE MINIMUM ANCHORAGE/LAP LENGTHS U.N.O. ANY REBAR WHICH IS CUT AND BENT ON SITE SHALL HAVE TWO APPLICATIONS OF A ZINC RICH PAINT APPLIED TO THE ENDS AND DAMAGED AREAS TO THE APPROVAL OF THE ENGINEER.
- 3.4 MINIMUM LAP LENGTHS UNO:

T25 - 1500 (60")

T20 - 1000 (40")

T16 - 800 (32")

T12 - 600 (24")

T10 - 500 (20")

3.5 MINIMUM ANCHORAGE LENGTHS UNO:

T20 - 850 (34")

T16 - 700 (28")

T12 - 550 (22")

T10 - 300 (12")

#### 4.0 MASONRY

- 4.1 WALLS TO BE CONSTRUCTED OF RUNNING BOND MASONRY.
- 4.2 FOR BED AND HEAD JOINTS: UNLESS OTHERWISE REQUIRED OR INDICATED ON THE PROJECT DRAWINGS, HEAD AND BED JOINTS SHALL BE  $\frac{3}{8}$ " (10mm) THICK, EXCEPT THAT THE THICKNESS OF THE BED JOINT OF THE STARTING COURSE PLACED OVER FOUNDATIONS SHALL NOT BE LESS THAN  $\frac{1}{4}$ " (7mm) AND NOT MORE THAN  $\frac{3}{4}$ " (19mm)
- 4.3 IN EACH WYTHE OF MASONRY LAID IN RUNNING BOND, HEAD JOINTS IN SUCCESSIVE COURSES SHALL BE OFFSET BY NOT LESS THAN ONE-FOURTH THE UNIT LENGTH.
- 4.4 FOR MASONRY UNIT PLACEMENT, THE MORTAR SHALL BE SUFFICIENTLY PLASTIC AND UNITS SHALL BE PLACED WITH SUFFICIENT PRESSURE TO EXTRUDE MORTAR FROM THE JOINT AND PRODUCE A TIGHT JOINT. DEEP FURROWING OF BED JOINTS THAT PRODUCES VOIDS IS NOT PERMITTED. ANY UNITS DISTURBED TO THE EXTENT THAT THE INITIAL BOND IS BROKEN AFTER INITIAL PLACEMENT SHALL BE REMOVED AND RE-LAID IN FRESH MORTAR. SURFACES TO BE IN CONTACT WITH MORTAR SHALL BE CLEAN AND FREE OF DELETERIOUS MATERIALS.
- 4.5 MASONRY UNITS SHALL CONFORM TO THE LATEST VERSION OF ASTM C90 (THE MINIMUM AVERAGE COMPRESSIVE STRENGTH OF 3 UNITS SHALL BE 2000 PSI BASED ON THE NET AREA OF THE UNITS.
- 4.6 MORTAR SHALL CONFORM TO THE LATEST VERSION OF ASTM C-270 AND SHALL BE OF GRADE S OR GREATER.
- 4.7 ALL CELLS TO BE FILLED ARE TO BE KEPT CLEAR OF OBSTRUCTIONS.
  ALL CELLS CONTAINING VERTICAL REINFORCING SHALL BE FILLED.
  CELLS BELOW BEARING BEAMS/LINTELS SHALL BE SOLID FILLED AND
  SHALL BE REINFORCED WITH MIN 1-T12 BAR. REBAR TO ANCHOR A
  A MINIMUM OF 2' INTO THE FOOTING. CELLS ARE TO BE SOLID FILLED TO
  FULL HEIGHT U.N.O.
- 4.8 FILLED BLOCK WORK MUST BE POURED IN MAXIMUM OF 4' HIGH LIFTS. CONCRETE MUST BE STOPPED 2" FROM THE TOP OF THE BLOCK TO ALLOW THE NEXT LIFT TO KEY TOGETHER.
- 4.9 WHERE NEW WALLS BUTT UP AGAINST EXISTING WALLS, A 4" KEY INTO THE EXISTING WALL IS REQUIRED EVERY 2ND COURSE OF BLOCK.
- 4.10 CONCRETE BOND BEAMS SHALL BE PROVIDED ON THE TOP OF ALL NEW WALLS W/ MINIMUM OF 8" DEEP AND THE SAME WIDTH AS WALL W/ 2 T12 MID HEIGHT CONTINUOUS THROUGHOUT THE BOND BEAM.

4.11 ALL CORNERS TO BE FILLED WITH MIN 2000 PSI CONCRETE, 3 CELLS IN ALL DIRECTIONS.

#### 5.0 FOUNDATIONS

- 5.1 ALL FOOTINGS AND FOUNDATIONS TO BEAR ON UNDISTURBED SOUND ROCK. BEARING MATERIAL IS TO REMAIN UNDISTURBED AND BE REVIEWED BY THE ENGINEER PRIOR TO PLACING THE CONCRETE FOR FOUNDATIONS.
- 5.2 ALL SHORING, SHEETING AND DEWATERING SHALL BE THE RESPONSIBILITY OF THE CONTRACTOR
- 5.3 THE CONTRACTOR SHALL TAKE PRECAUTIONS TO PROTECT ALL EXISTING AND SURROUNDING INFRASTRUCTURE.
- 5.4 UNDERSIDE OF SCREENING PLANT FOUNDATIONS TO BE RAISED WITH A LAYER OF CONCRETE BLINDING/LEAN MIX AS REQUIRED TO ACHIEVE THE SPECIFIED TOP OF CONCRETE FOOTING ELEVATION.
- 5.5 BACKFILL MATERIAL SHALL BE FREE FROM ORGANIC MATTER, CONSTRUCTION DEBRIS AND LARGE ROCKS. BACKFILL SHALL BE WELL GRADED AND PLACED IN LAYERS NOT EXCEEDING 6". THE BACKFILL SHALL BE WATERED AND COMPACTED TO A MINIMUM OF 95% COMPACTION.

# 6.0 INSPECTION AND TESTING

6.1 CONTRACTOR TO PROVIDE 48 HOURS NOTICE TO THE ENGINEER OF RECORD FOR THE INSPECTION OF ALL REINFORCEMENT, INCLUDING MASONRY REINFORCEMENT PRIOR TO POURING CONCRETE. NO WORK SHALL BE COVERED UP UNTIL SUCH TIME AS THE OWNER'S REPRESENTATIVE HAS APPROVED THE WORK.

#### 7.0 DEMOLITION/EXCAVATIONS

- 7.1 WHERE NECESSARY, THE CONTRACTOR SHALL DESIGN AND PROVIDE INTERIOR AND EXTERIOR SHORING, BRACING, OR SUPPORT TO PREVENT MOVEMENT, SETTLEMENT, OR COLLAPSE OF THE STRUCTURE OR ELEMENT TO BE DEMOLISHED, AND ADJACENT FACILITIES OR WORK TO REMAIN.
- 7.2 IF UNEXPECTED MECHANICAL, ELECTRICAL OR STRUCTURAL ELEMENTS ARE ENCOUNTERED, THE CONTRACTOR SHALL SUBMIT DETAILS OF SUCH TO THE ENGINEER.
- 7.3 THE CONTRACTOR SHALL LOCATE AND IDENTIFY EXISTING UNDERGROUND UTILITIES WITHIN THE SITE EXTENTS. IF UTILITIES ARE TO REMAIN, THE CONTRACTOR SHALL ENSURE THAT THE UTILITIES ARE SUPPORTED AND PROTECTED THROUGHOUT THE WORKS.

#### 8.0 CONNECTIONS

- 8.1 ALL NAILS, BOLTS, SCREWS, CLIPS, ANCHORS AND HURRICANE TIES SHALL BE GALVANIZED OR STAINLESS STEEL.
- 8.2 IF GALVANIZED: ALL NUTS, BOLTS, WASHERS, NAILS, SCREWS, AND OTHER FASTENERS SHOULD BE HOT DIPPED GALVANIZED IN ACCORDANCE WITH ASTM A153. ALL JOIST HANGERS, HURRICANE CLIPS AND OTHER CONNECTIONS SHALL BE HOT DIPPED GALVANIZED IN ACCORDANCE WITH ASTM A525 TO A MINIMUM OF G60.
- 8.3 ANCHOR BOLTS SHALL BE SET IN THE CORRECT LOCATIONS USING TEMPLATES AND NOT FORCE FIT AFTER CONCRETING.
- 8.4 NAILS AND NAILED CONNECTIONS SHALL COMPLY WITH APPENDIX B : NAIL FASTENING SCHEDULE IN THE BERMUDA RESIDENTIAL BUILDING CODE 2014.
- 8.5 BOLT HOLES SHALL BE NO LARGER THAN  $\frac{1}{16}$ " GREATER THAN THE BOLT SHANK DIAMETER. ALL BOLTED JOINTS SHALL HAVE WASHERS FITTED UNDER THE HEAD OF THE BOLT AND UNDER THE NUT. THE SIZE OF WASHERS FOR  $\frac{1}{2}$ " BOLTS AND UNDER SHALL BE A MINIMUM OF 2" DIAMETER X  $\frac{1}{8}$ " THICK AND FOR  $\frac{5}{8}$ " BOLTS A MINIMUM OF 2  $\frac{1}{2}$ " DIAMETER AND  $\frac{3}{16}$ " THICK.
- 8.6 BOLT STRENGTH TO BE A MINIMUM OF CLASS 4.6 OR EQUIVALENT.
- 8.7 ANCHOR ROD/BOLT/CONNECTION INSTALLATIONS MUST FOLLOW THE INSTRUCTIONS FOR USE (IFU) DOCUMENTATION PROVIDED WITH THE PRODUCT.




25 Serpentine Road, Pembroke HM 07


Email: info@iepc.bm www.iepc.bm

**REVISIONS** 00 2024-08-09 RGW ISSUED FOR PRELIMINARY PRICING PROJECT DETAILS PUBLIC WORKS QUARRY & DEPOT QUARRY ROAD HAMILTON PARISH BERMUDA STRUCTURAL NOTES **DESIGN BY: RGW** CHECKED BY: RB JOB No: 09-AUG-2024 SHEET No: **REVISION:** 

S-001

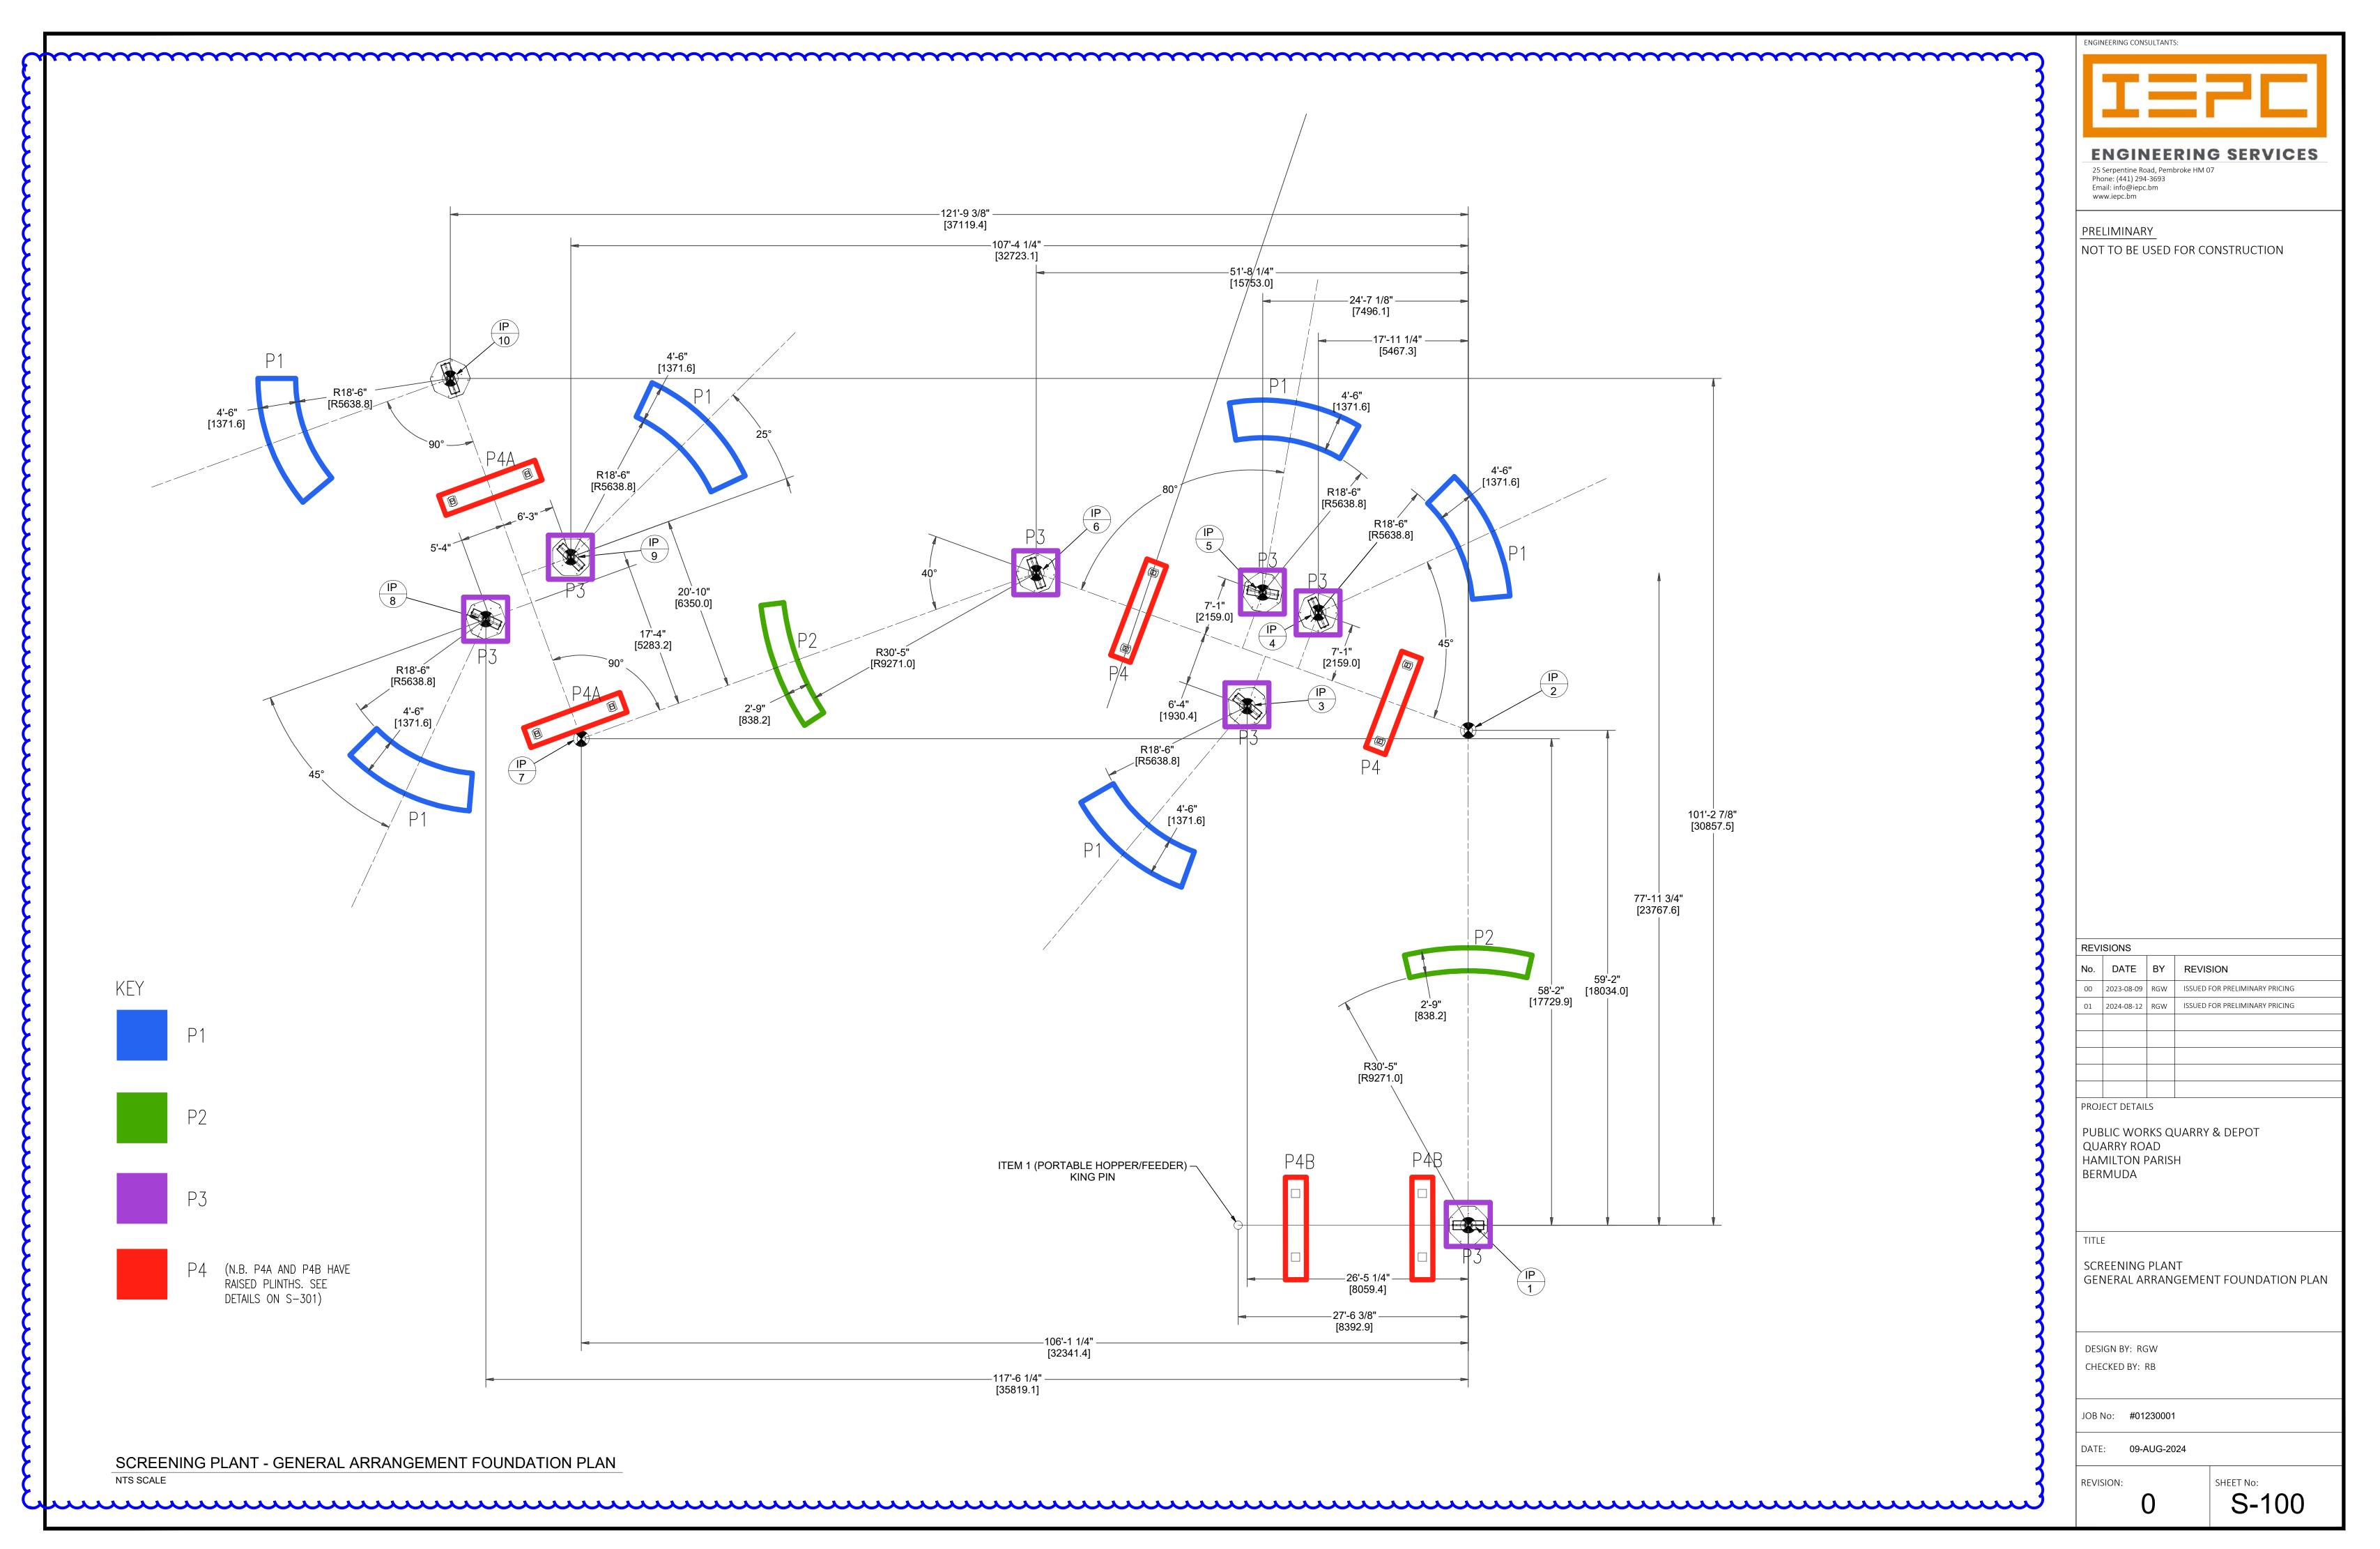

ASphalt Plant Site Works - ADDDENDA #11

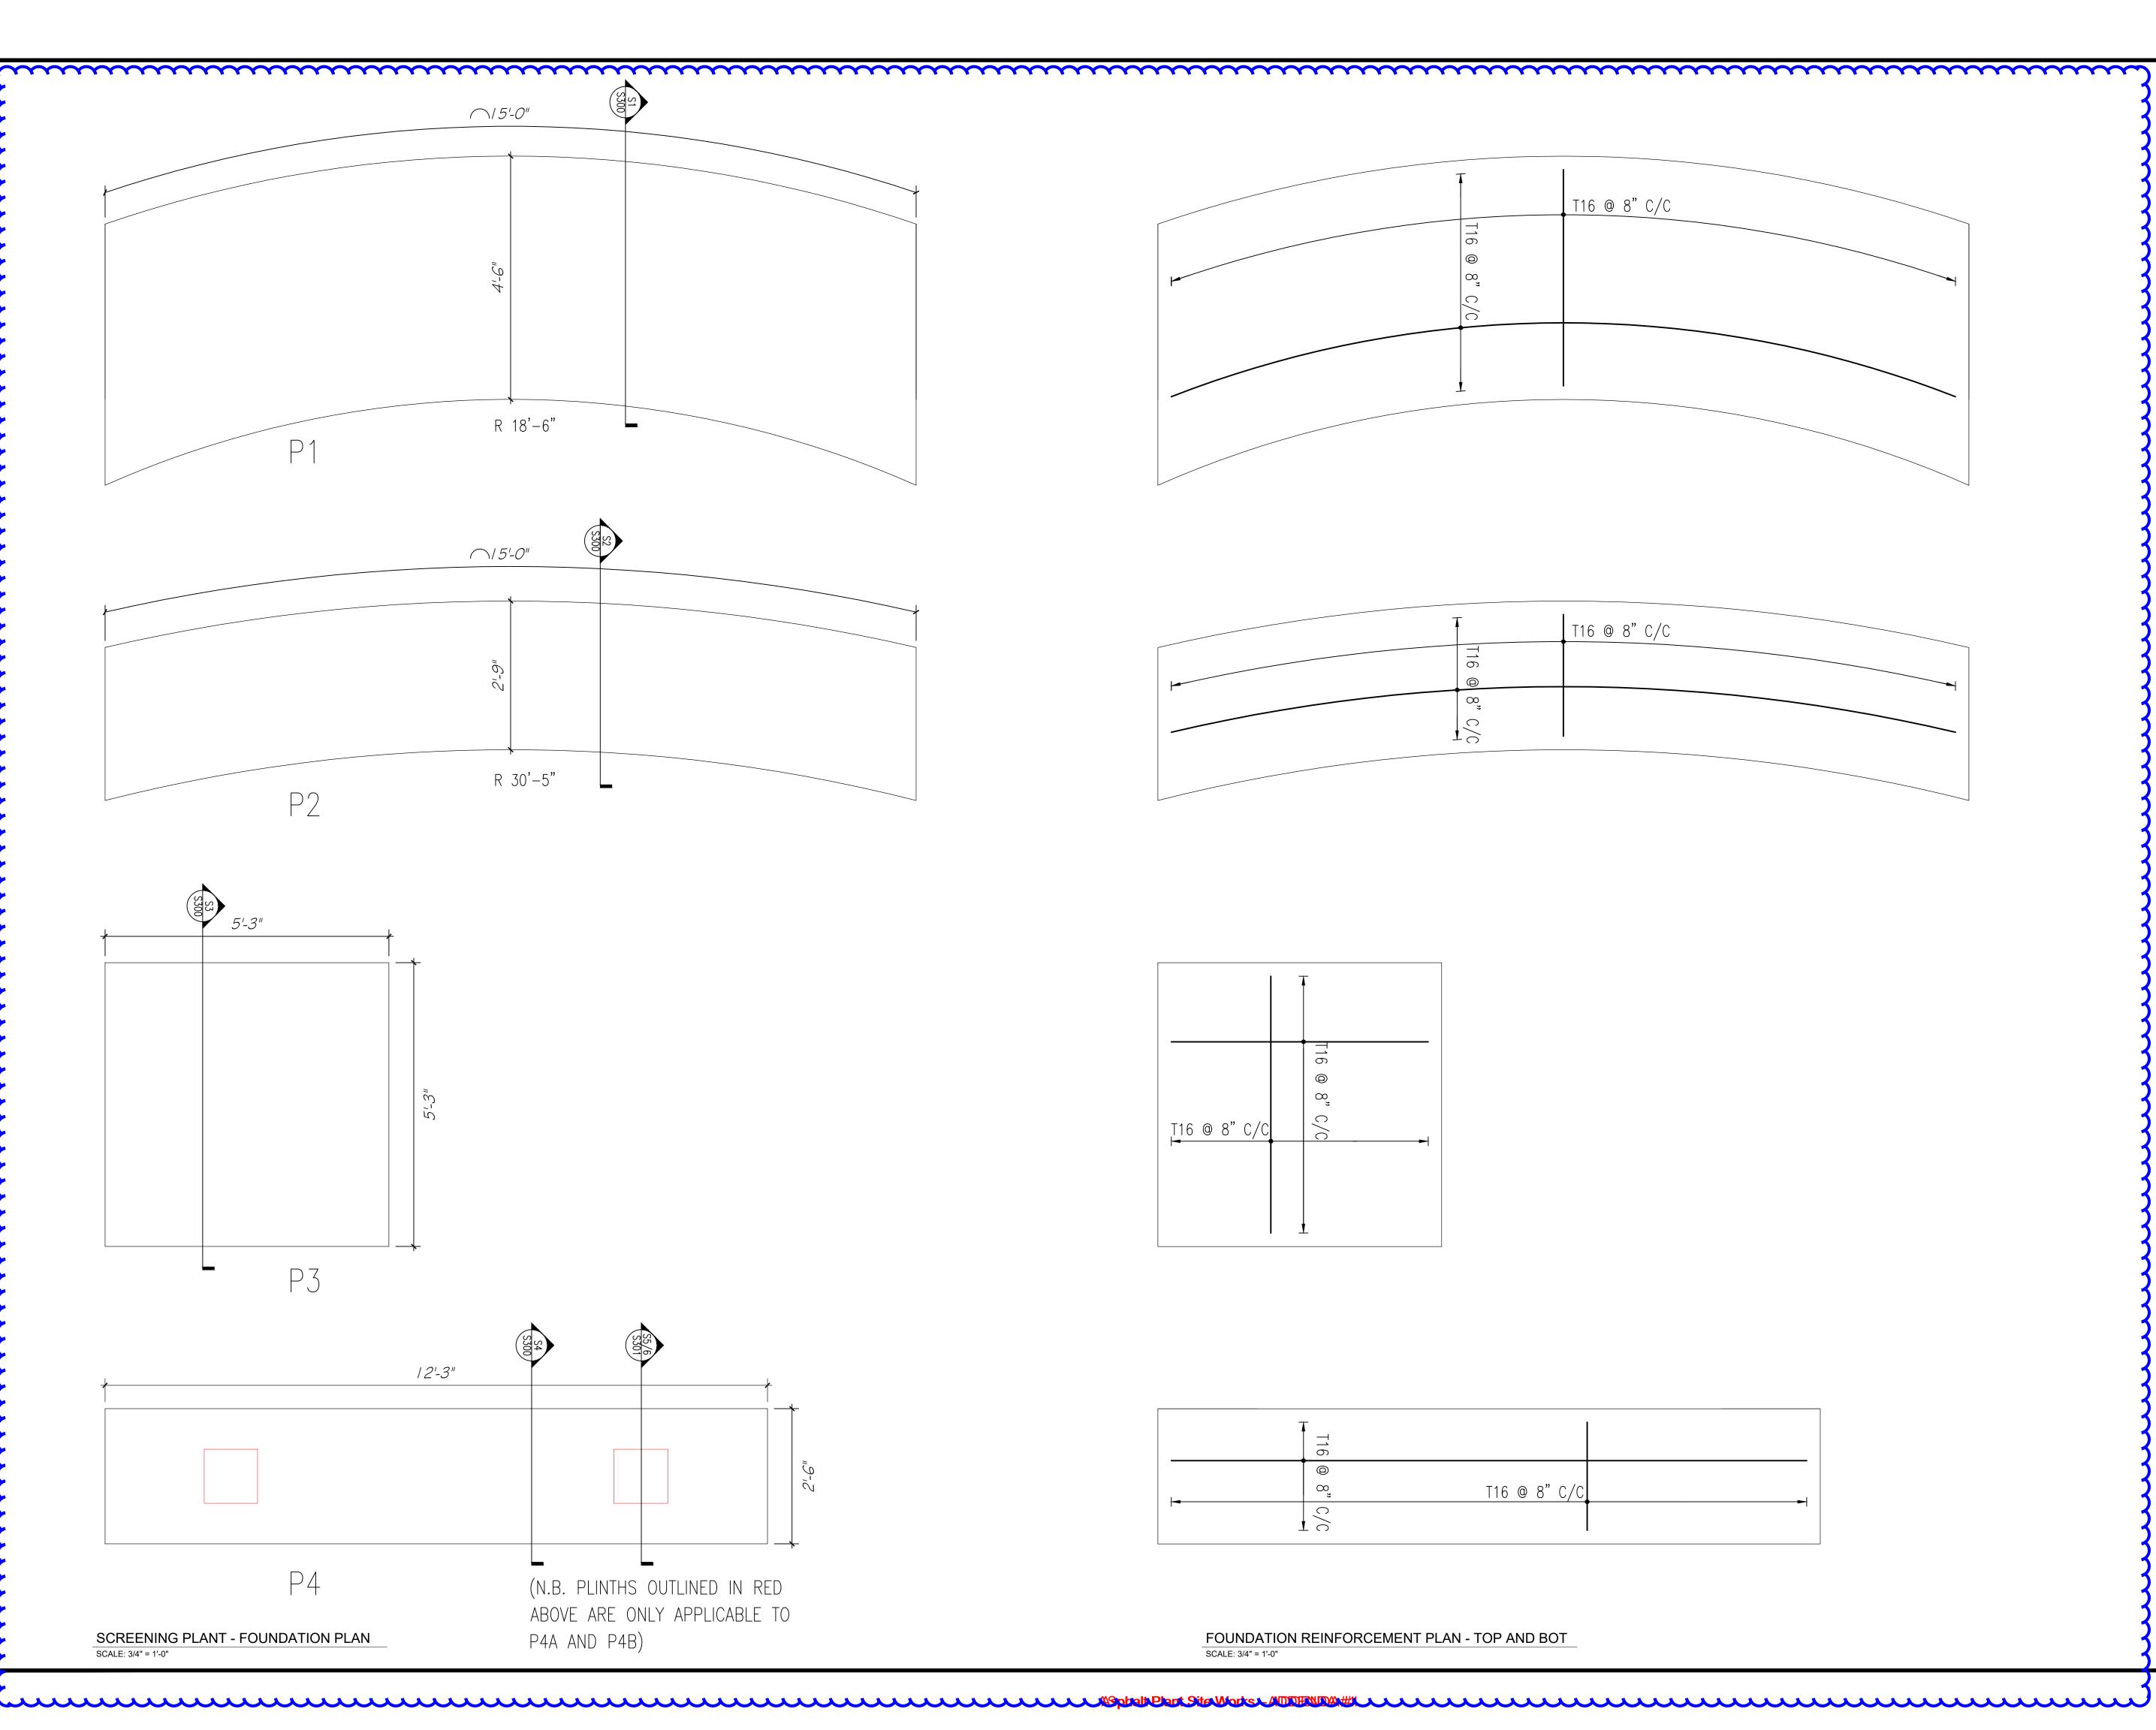



ENGINEERING SERVICES

25 Serpentine Road, Pembroke HM 07 Phone: (441) 294-3693 Email: info@iepc.bm www.iepc.bm

PRELIMINARY

NOT TO BE USED FOR CONSTRUCTION

REVISIONS

No. DATE BY REVISION

00 2024-08-09 RGW ISSUED FOR PRELIMINARY PRICING

01 2024-08-12 RGW ISSUED FOR PRELIMINARY PRICING

PROJECT DETAILS

BERMUDA

PUBLIC WORKS QUARRY & DEPOT QUARRY ROAD HAMILTON PARISH

TITLE

SCREENING PLANT
PAD FOOTING FOUNDATION PLAN


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CHECKED BY: RB


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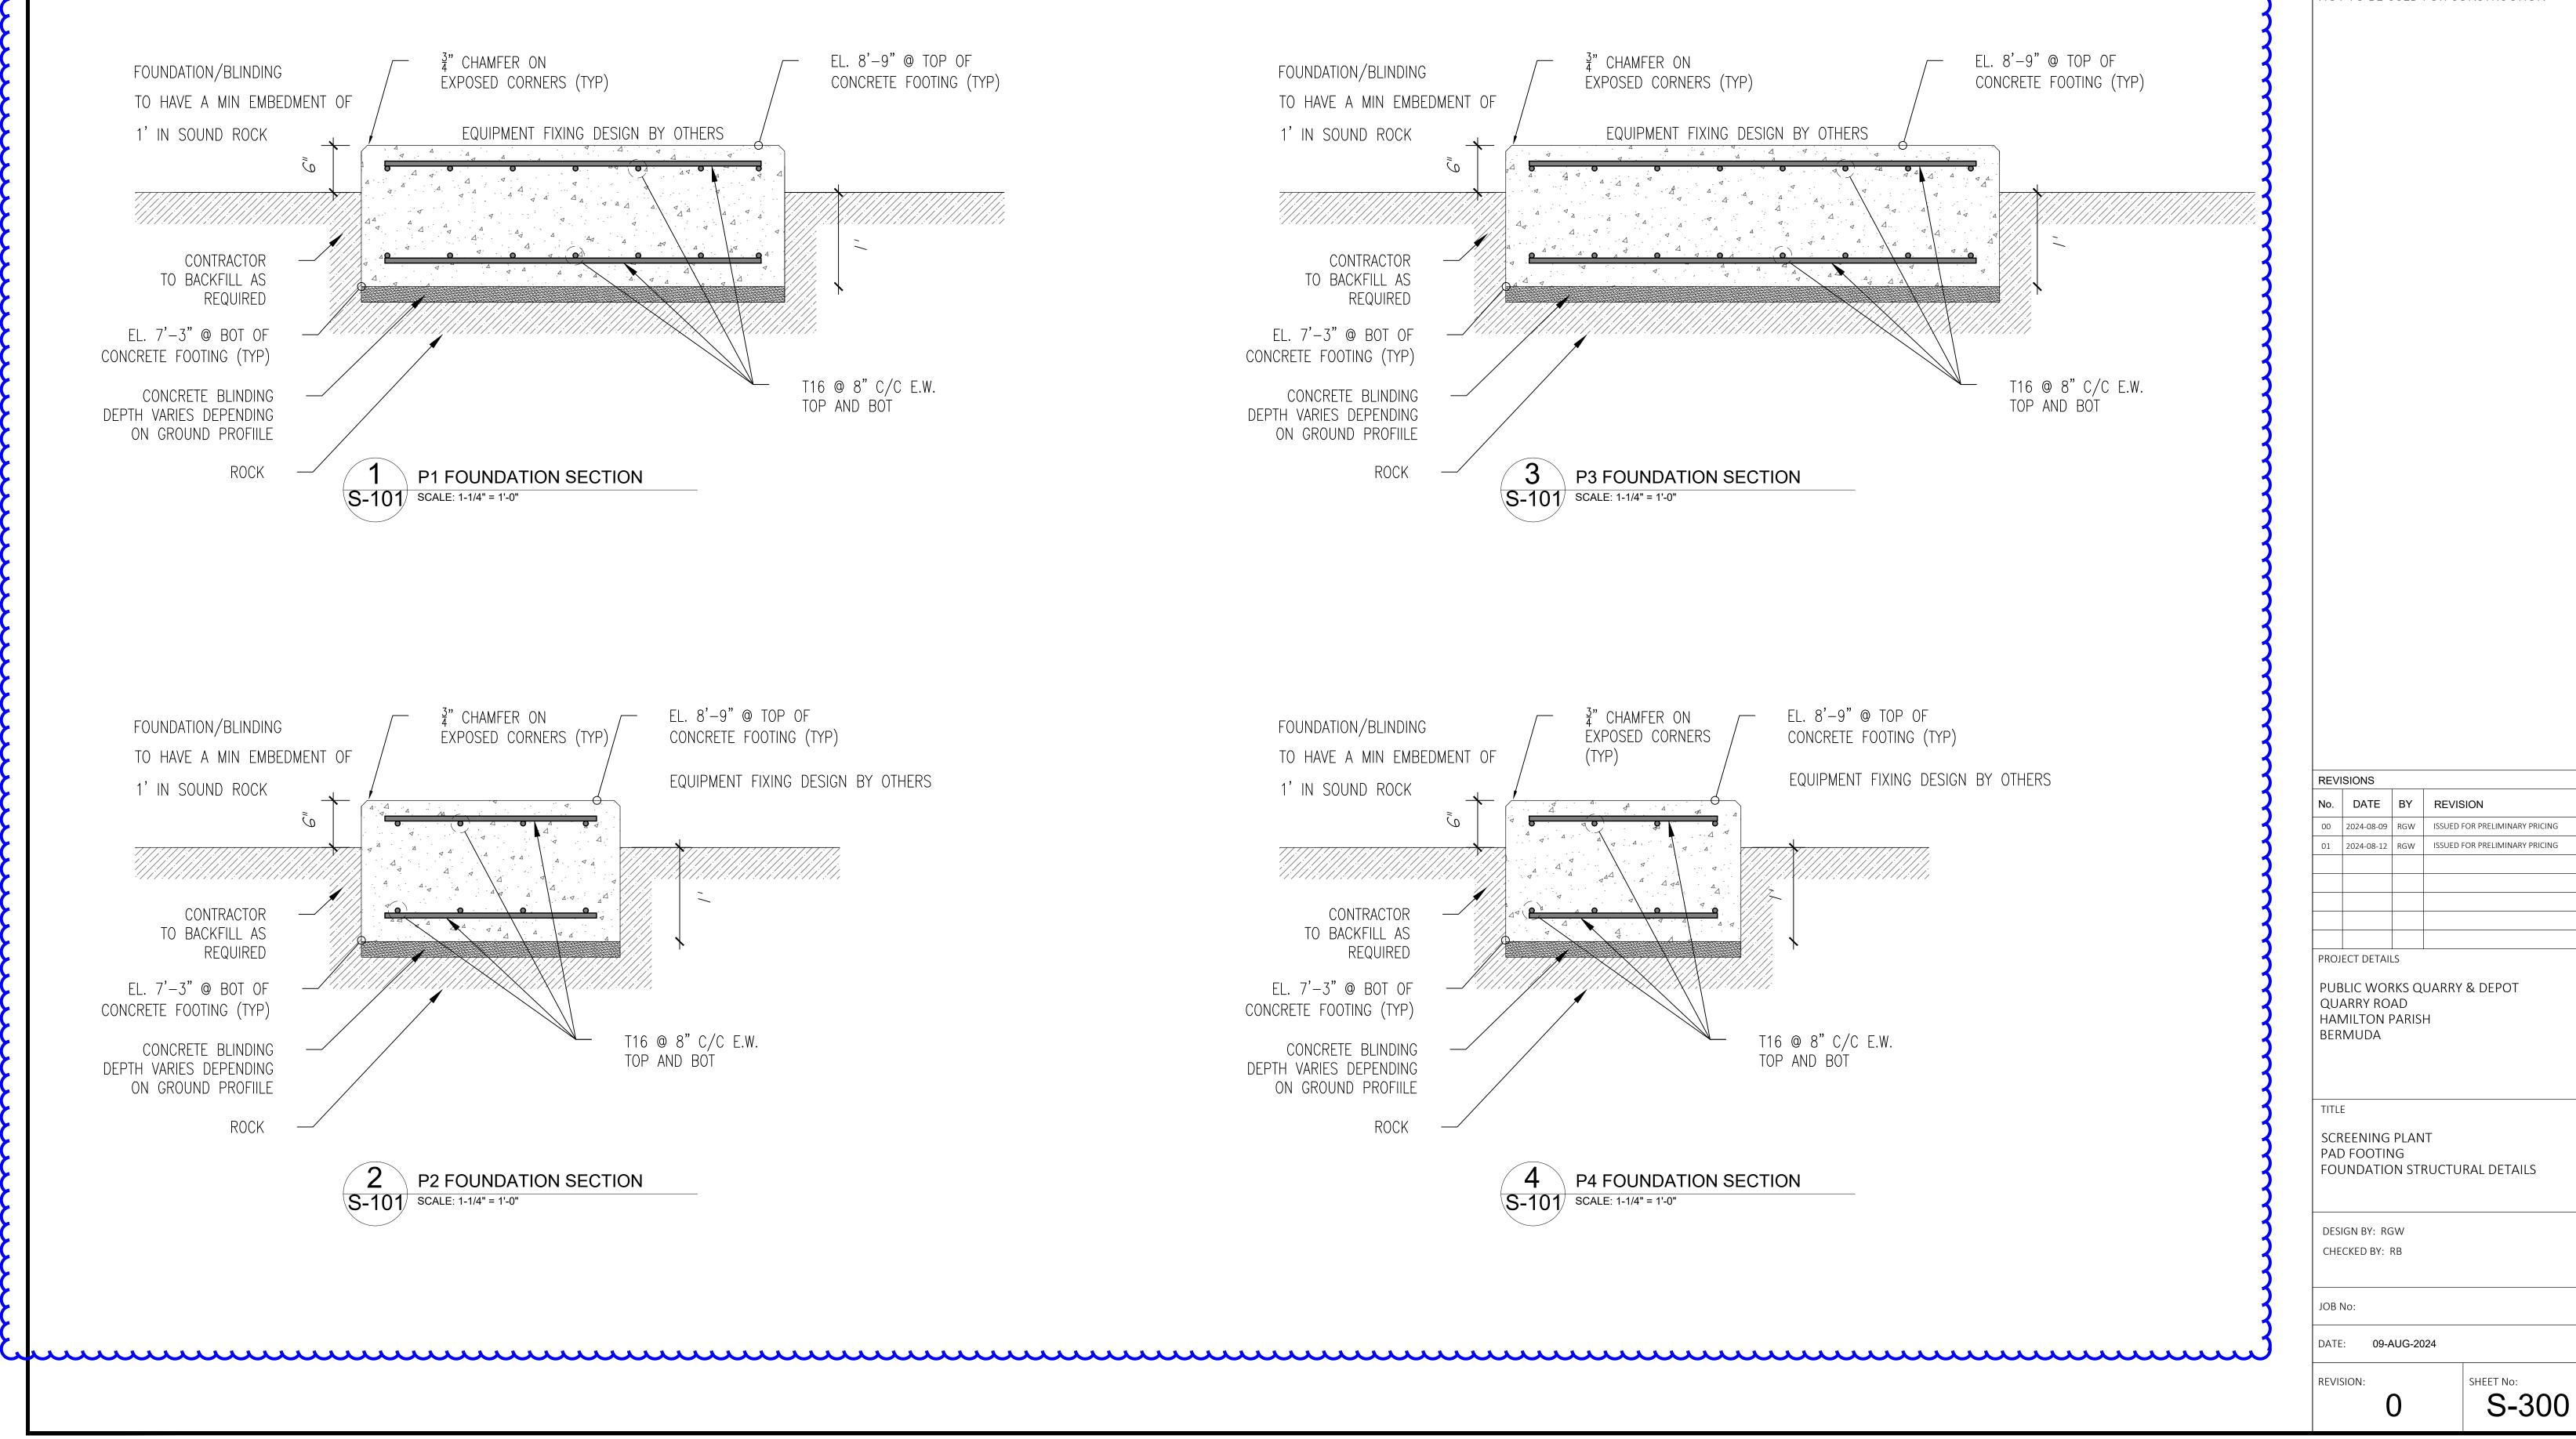
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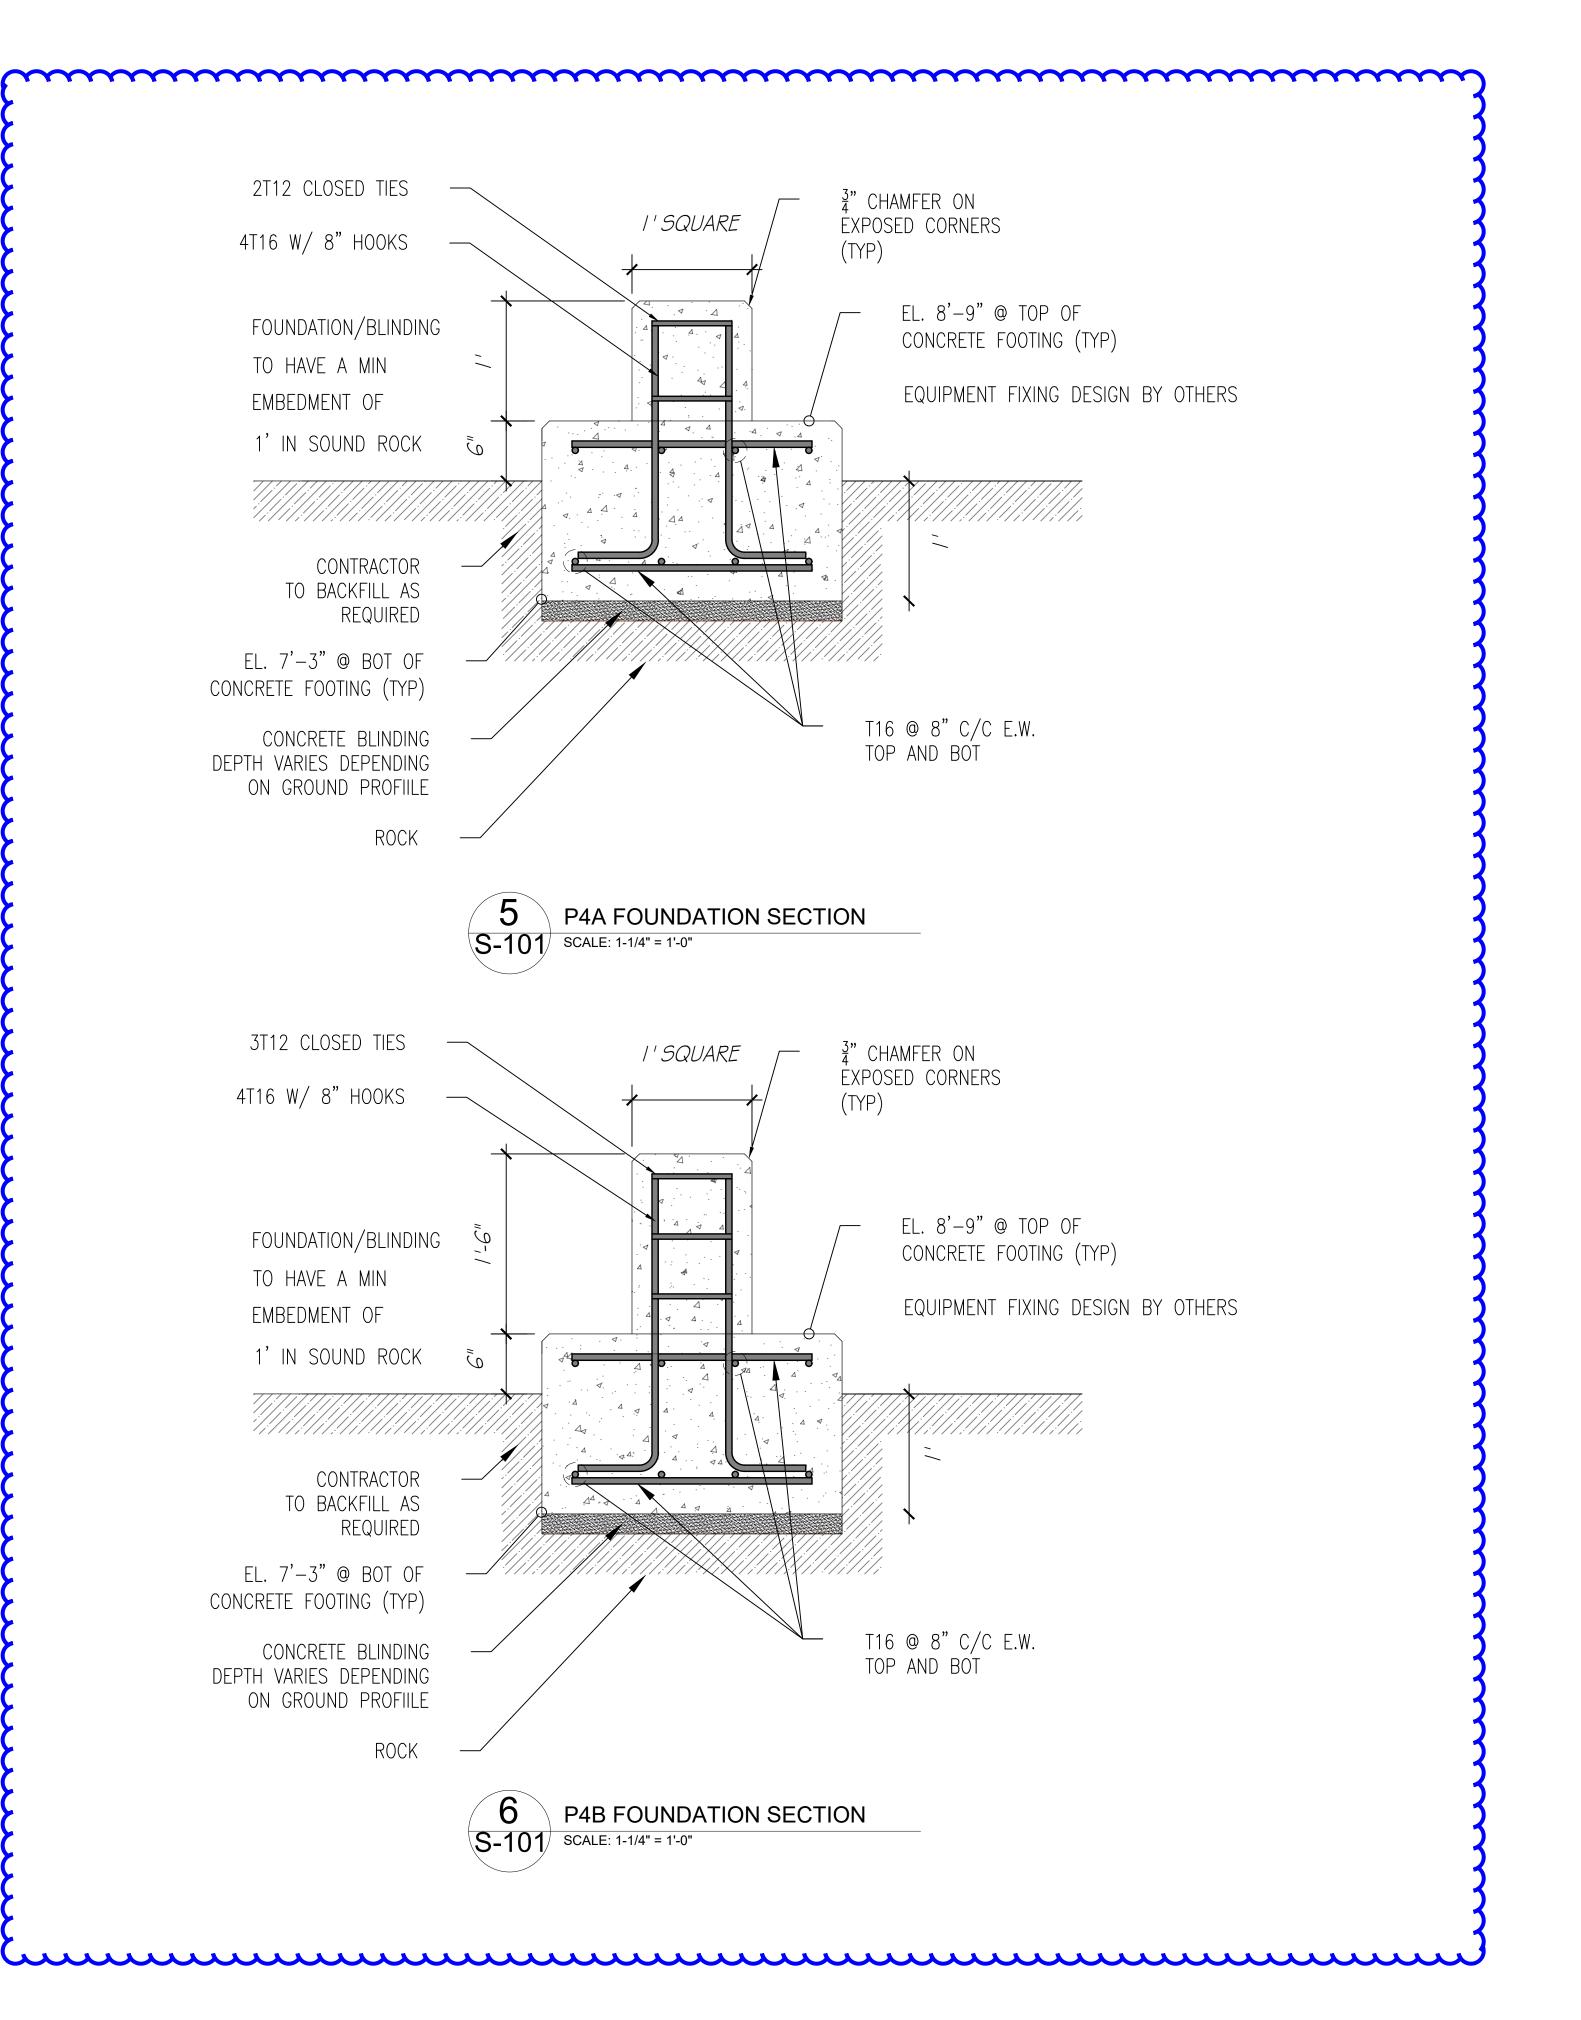
REVISION:

SHEET No:
S-101





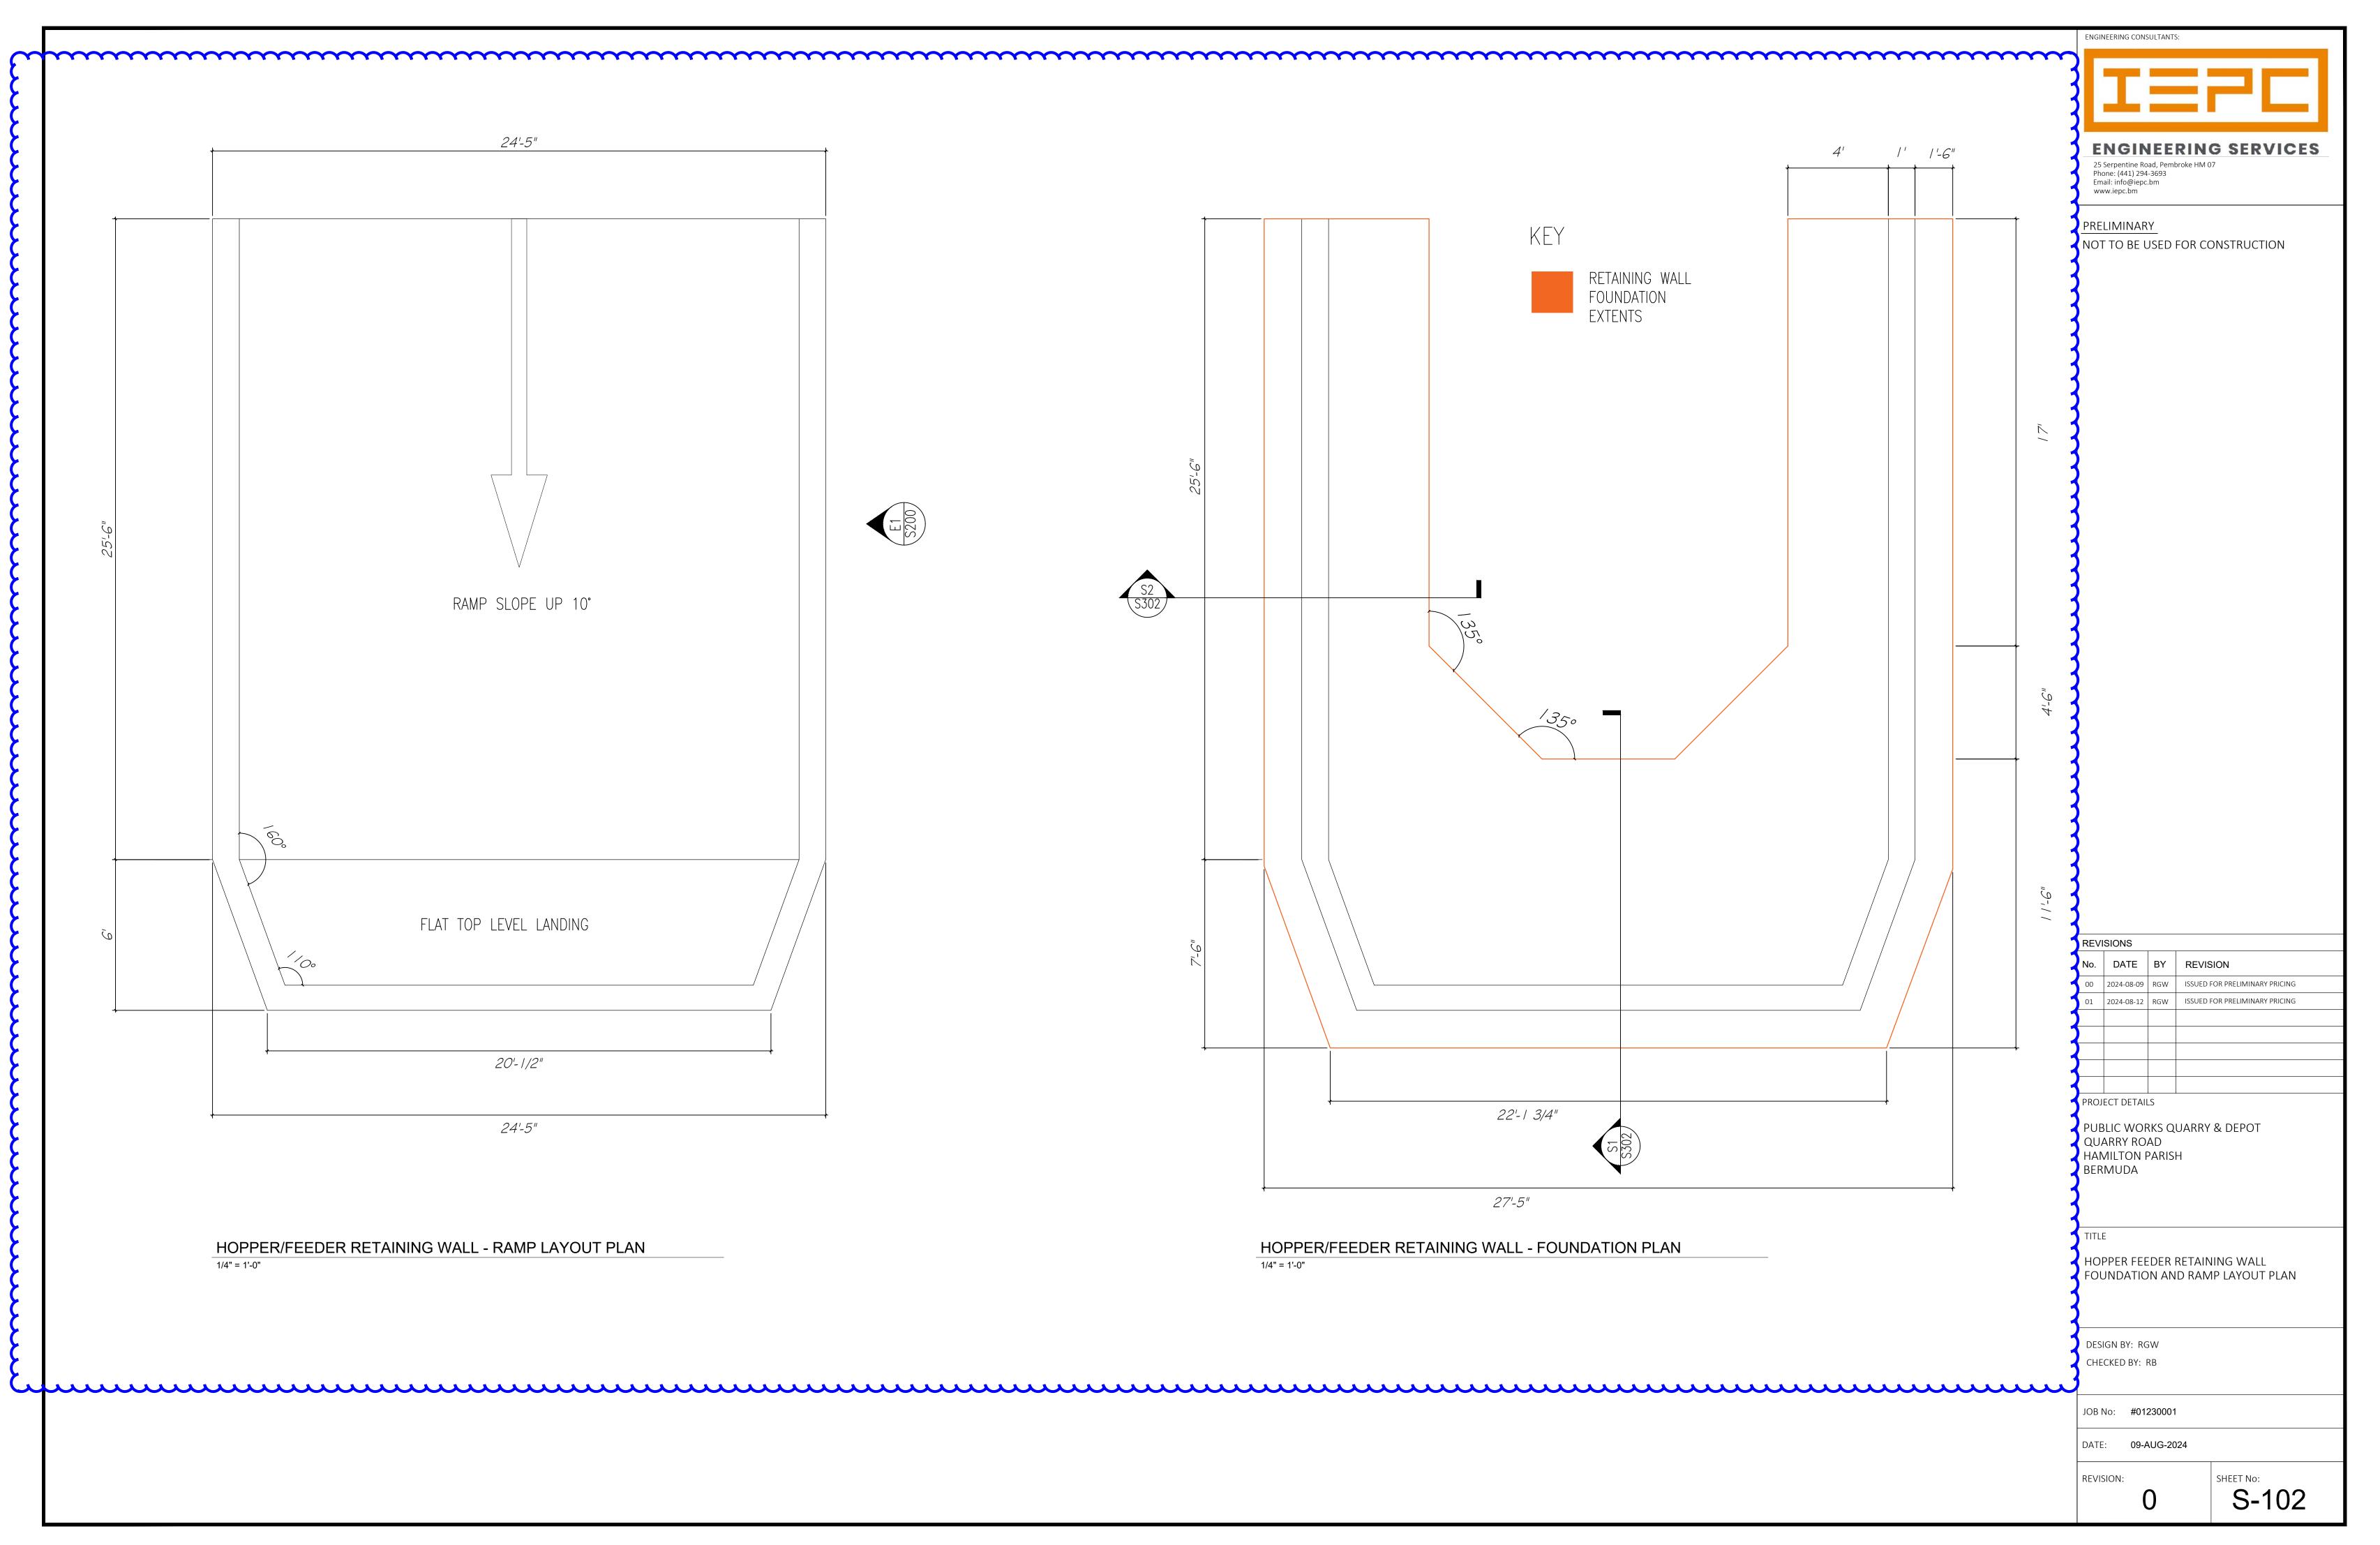

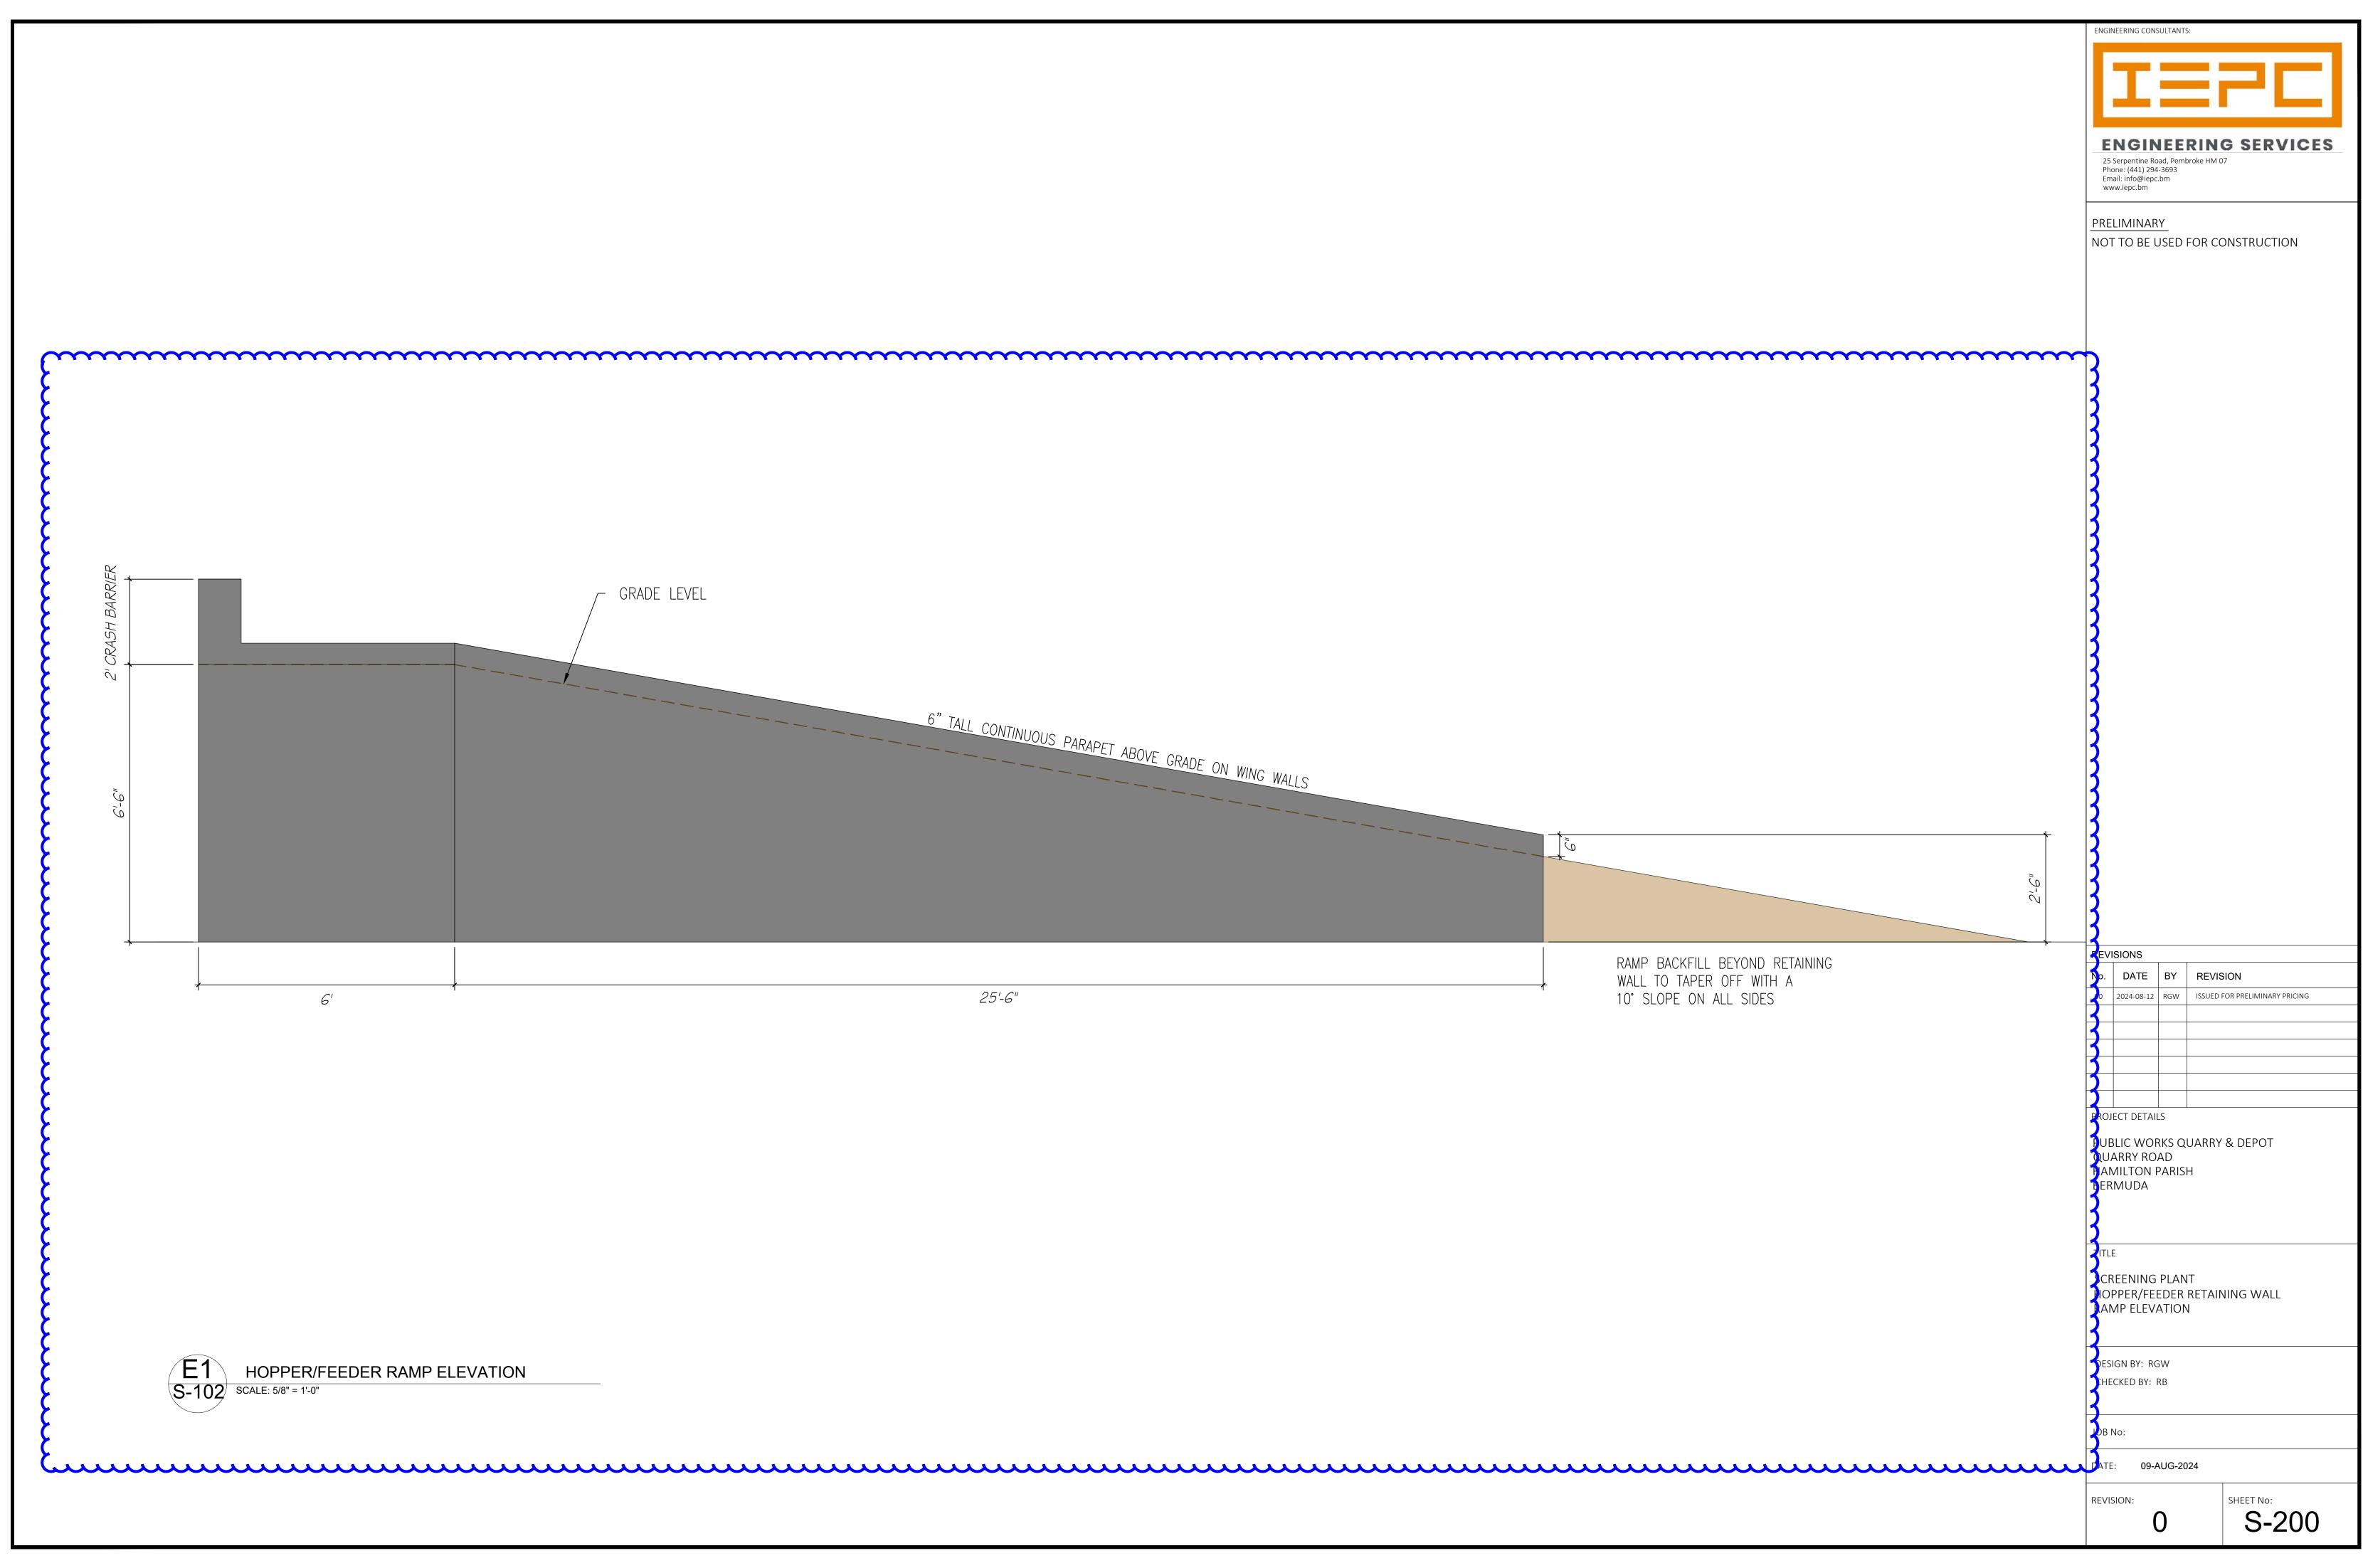

ENGINEERING CONSULTANTS:

# **ENGINEERING SERVICES**

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PRELIMINARY

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No. DATE BY REVISION

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01 2024-08-12 RGW ISSUED FOR PRELIMINARY PRICING

PROJECT DETAILS

PUBLIC WORKS QUARRY & DEPOT QUARRY ROAD HAMILTON PARISH BERMUDA

TITLE

SCREENING PLANT
PAD FOOTING
FOUNDATION STRUCTURAL DETAILS


DESIGN BY: RGW
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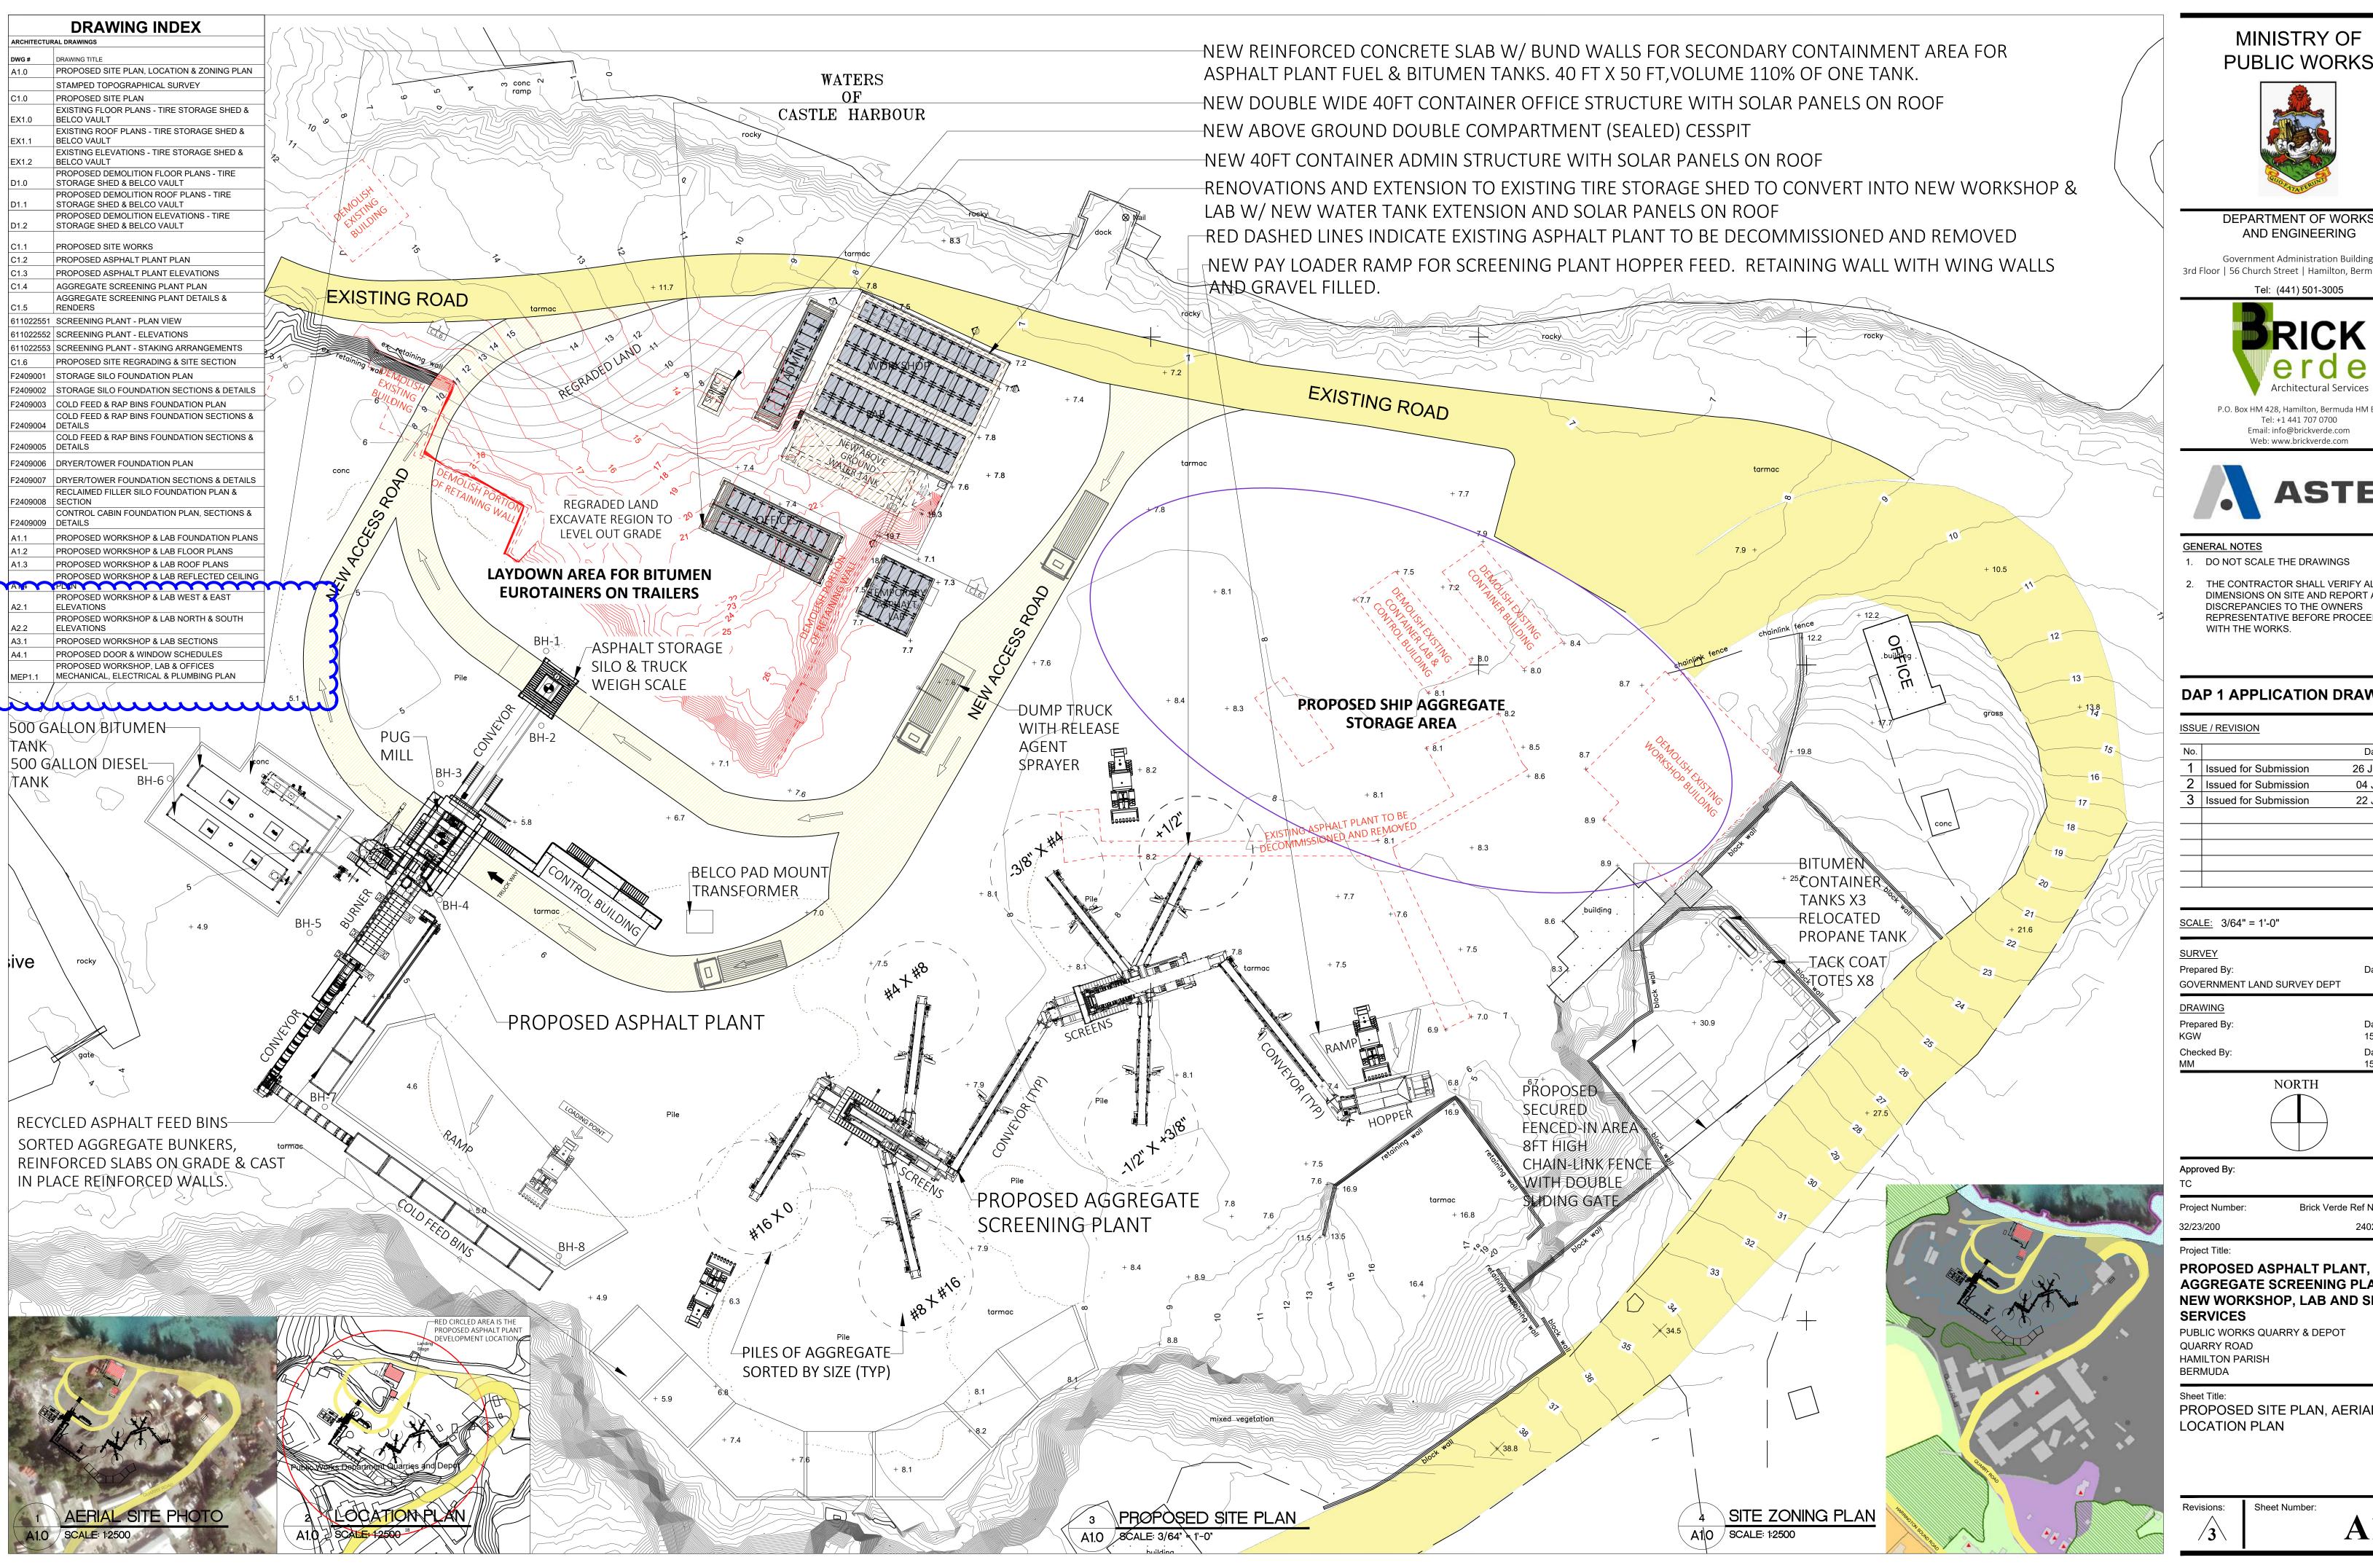
DATE: 09-AUG-2024

REVISION:

SHEET No:



ASphalt Plant Site Works - ADDDENDA #11

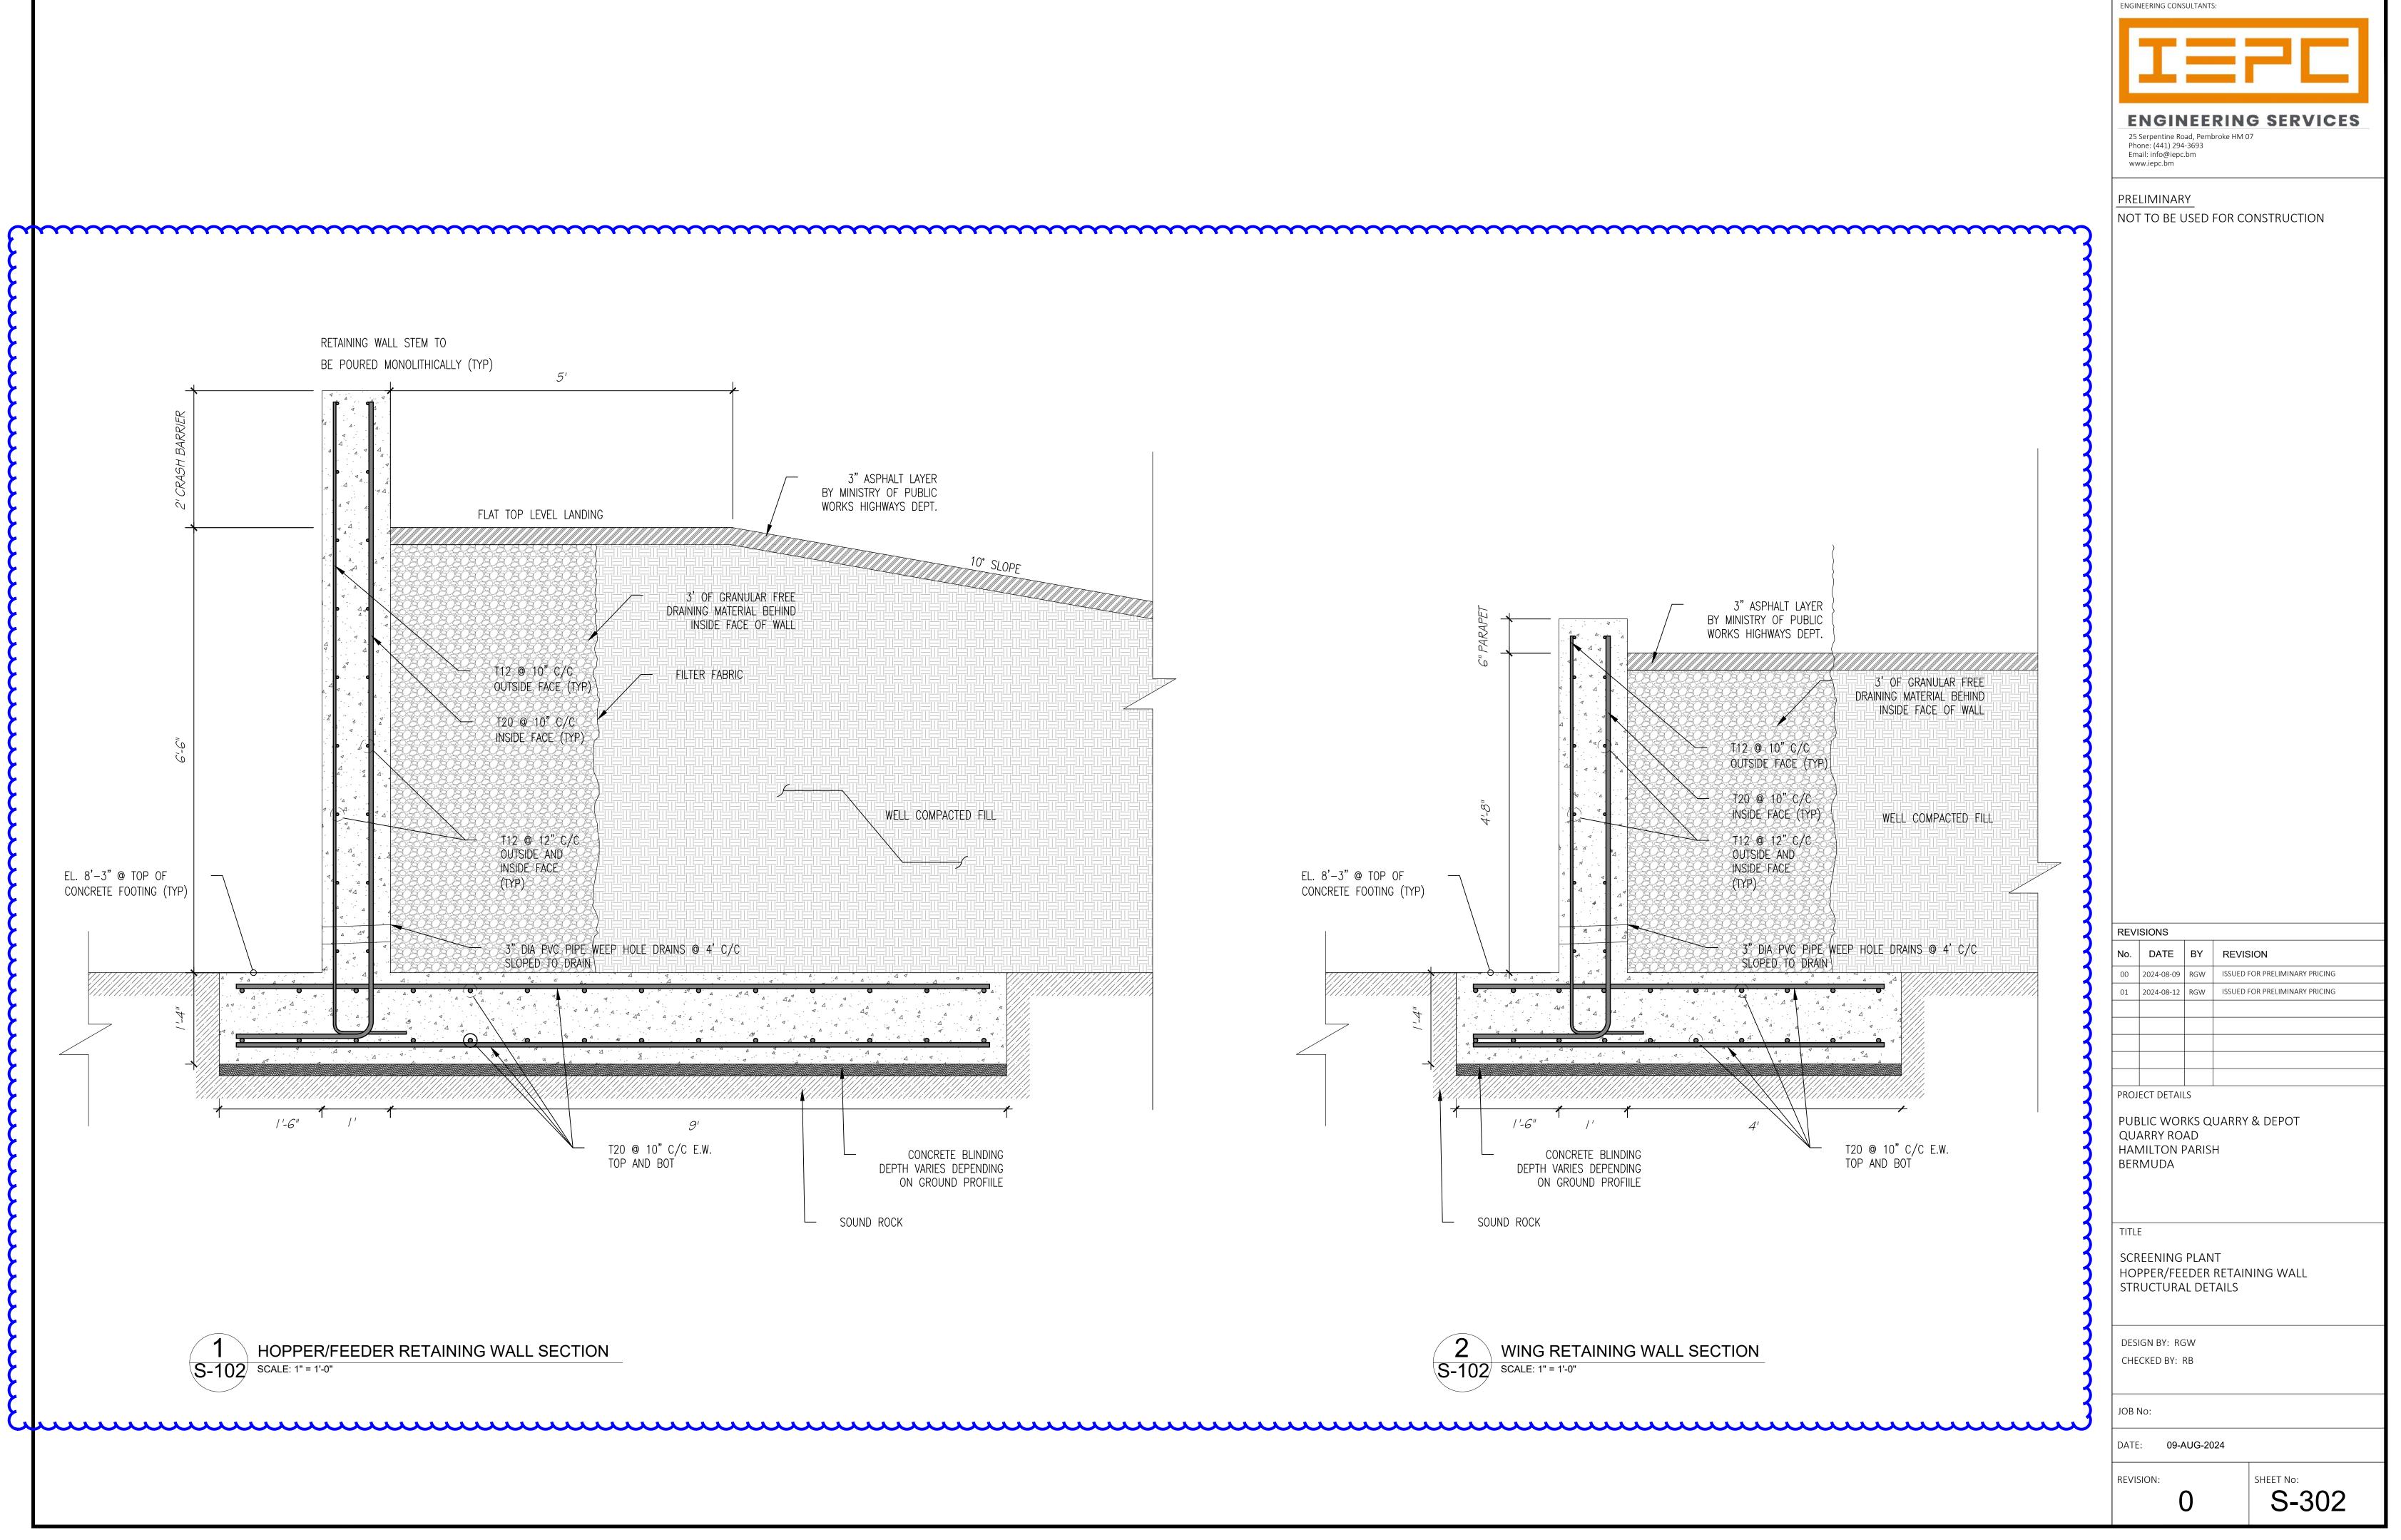

Government Administration Building, 3rd Floor | 56 Church Street | Hamilton, Bermuda HM12



P.O. Box HM 428, Hamilton, Bermuda HM BX Email: info@brickverde.com



2. THE CONTRACTOR SHALL VERIFY ALL DIMENSIONS ON SITE AND REPORT ANY DISCREPANCIES TO THE OWNERS REPRESENTATIVE BEFORE PROCEEDING

#### DAP 1 APPLICATION DRAWINGS


# 26 Jun 2024 04 Jul 2024 22 Jul 2024

15/05/2024 Date: 15/05/2024

Brick Verde Ref Number: 240219AP

AGGREGATE SCREENING PLANT, **NEW WORKSHOP, LAB AND SITE** 

PROPOSED SITE PLAN, AERIAL &

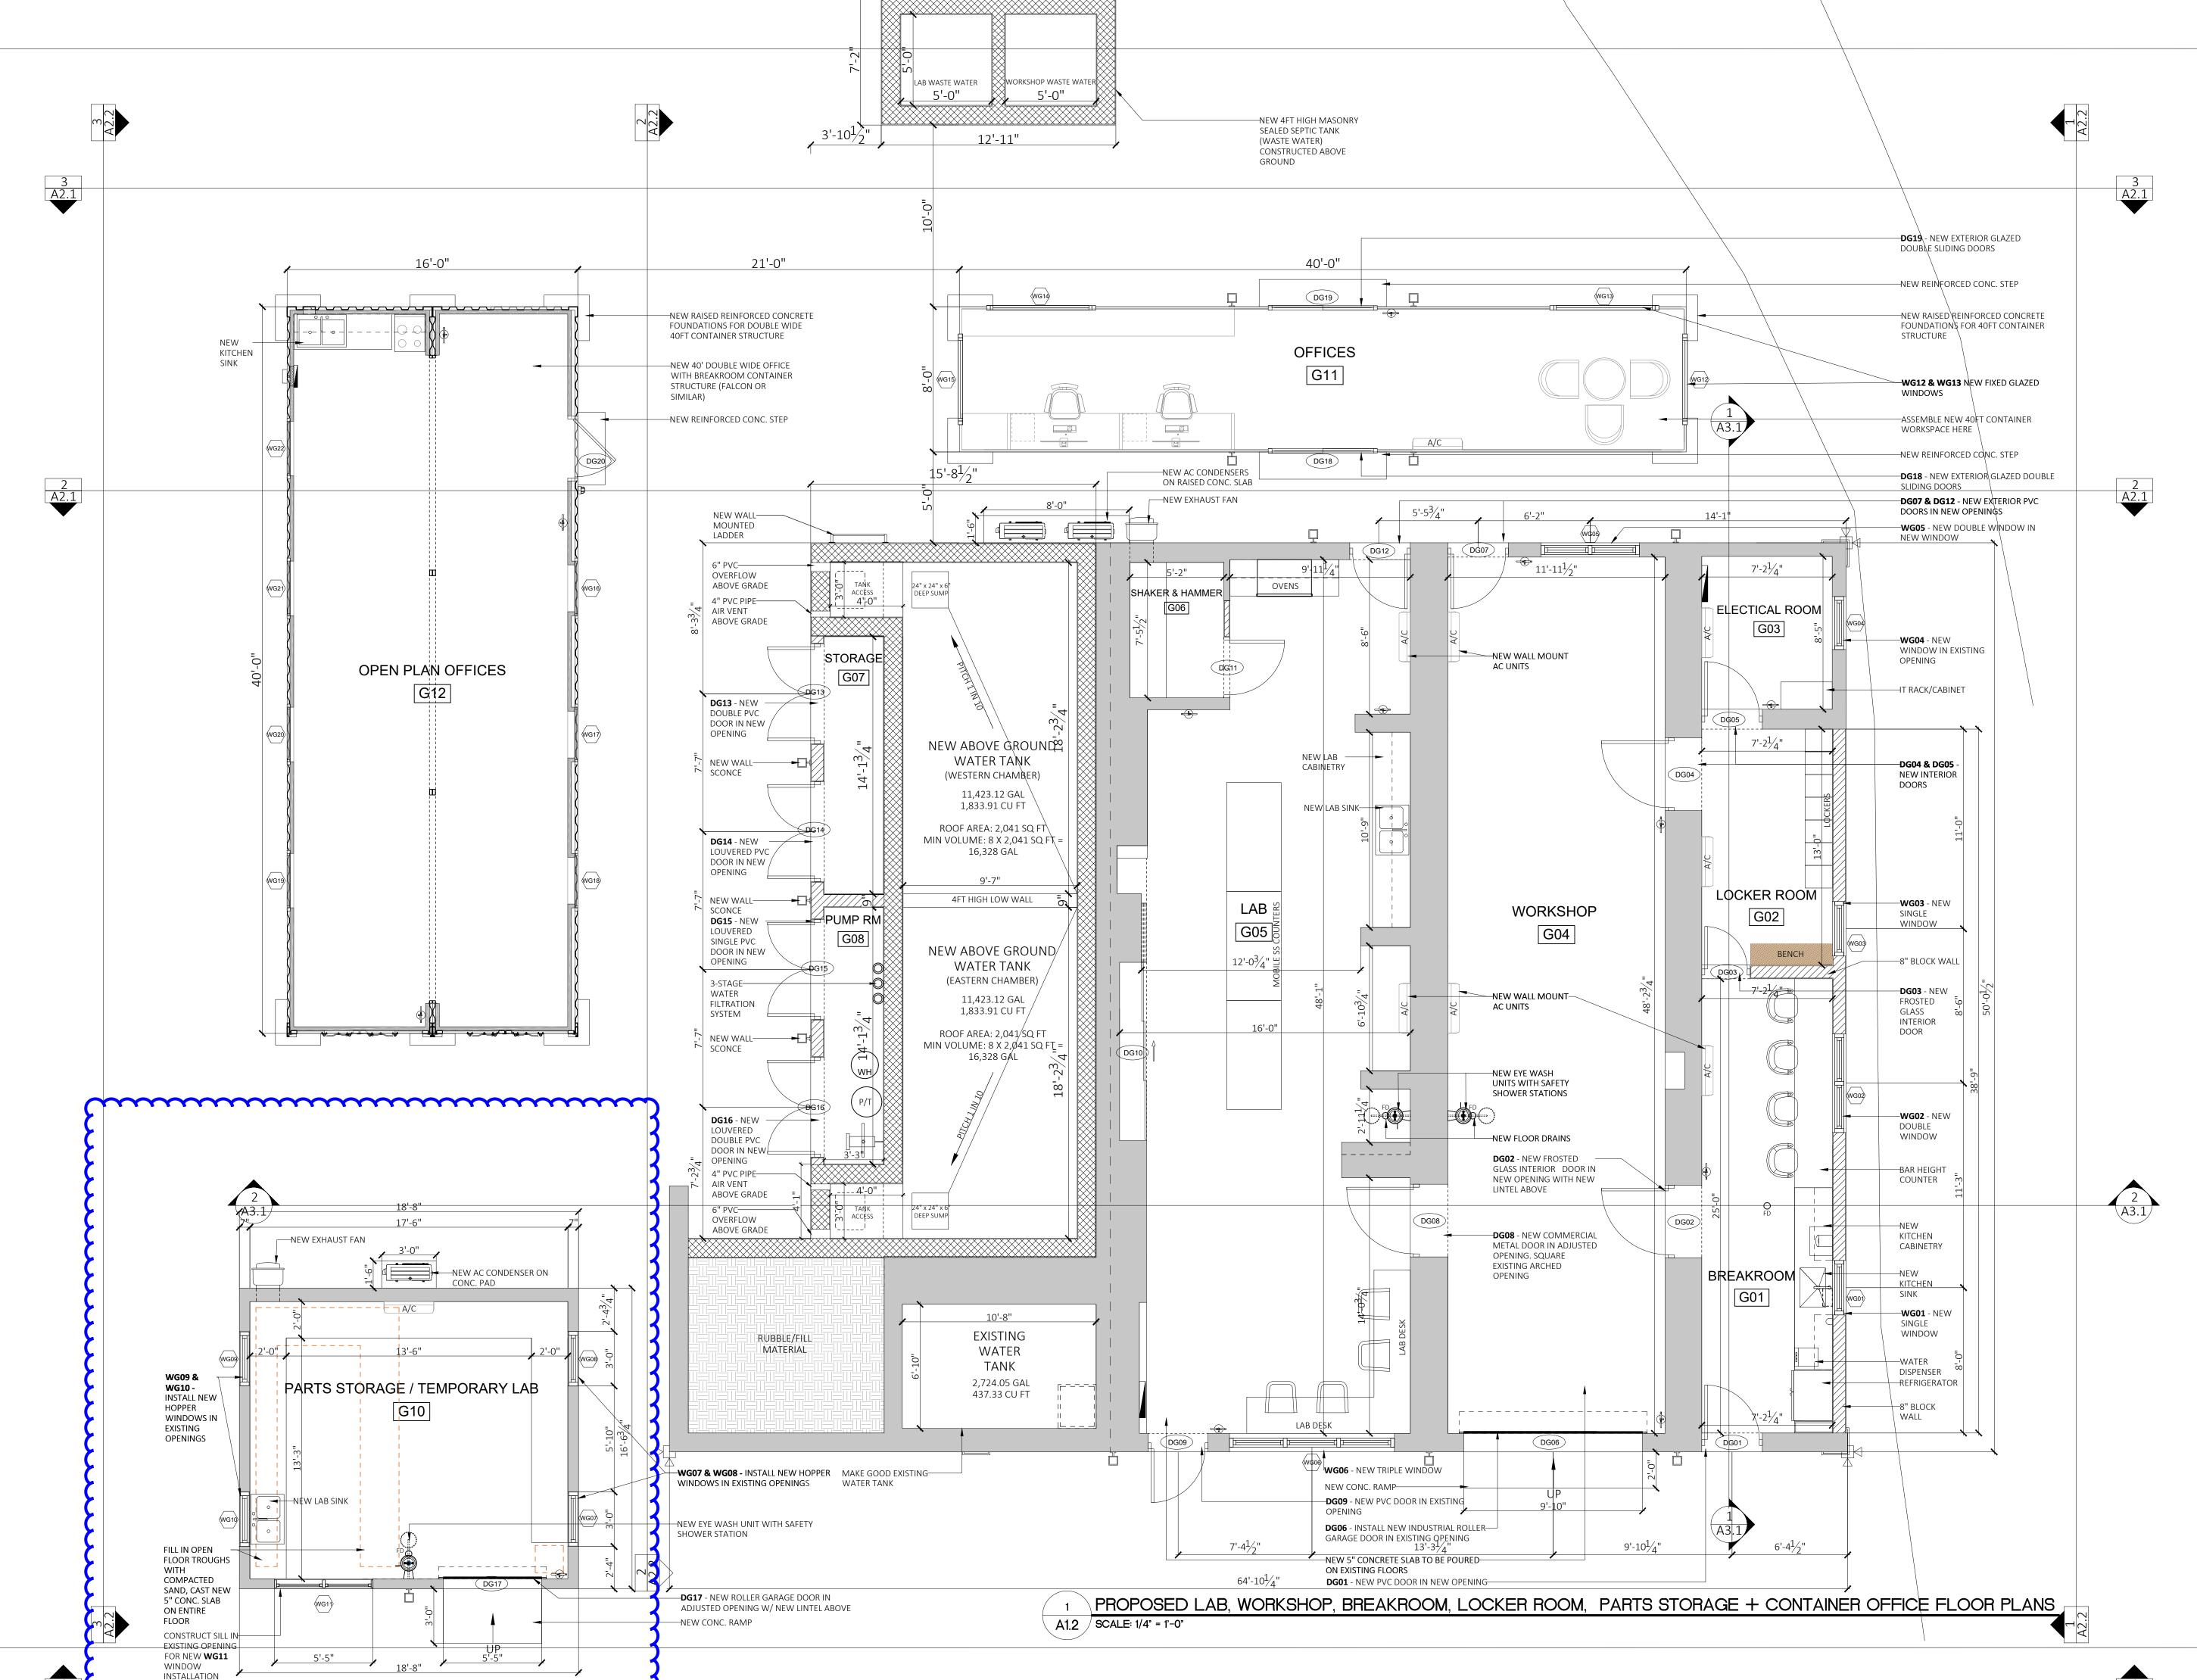

# MINISTRY OF **PUBLIC WORKS**




#### DEPARTMENT OF WORKS AND ENGINEERING

Government Administration Building, 3rd Floor | 56 Church Street | Hamilton, Bermuda HM12 Tel: (441) 501-3005



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**GENERAL NOTES** 

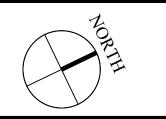1. DO NOT SCALE THE DRAWINGS

2. THE CONTRACTOR SHALL VERIFY ALL DIMENSIONS ON SITE AND REPORT ANY DISCREPANCIES TO THE OWNERS REPRESENTATIVE BEFORE PROCEEDING WITH THE WORKS.

#### DAP 1 APPLICATION DRAWINGS

<ul> <li>1 Issued for DAP 1 Submission 26 Jun</li> <li>2 Issued for DAP 1 Submission 22 July</li> <li>3 Issued for DAP 1 Submission 26 July</li> </ul>	No.		Date:
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3 Issued for DAP 1 Submission 26 July	2	Issued for DAP 1 Submission	22 July 2
	3	Issued for DAP 1 Submission	26 July 2

SCALE:	1/4" = 1'-0
SCALL.	1/4 - 1-0

SURVEY Prepared By: GOVERNMENT LAND SURVEY DEPT	Date:
DESIGN	
Prepared By:	Date:
KGW	15/05/2024
Checked By:	Date:
MM	15/05/2024
<u>DRAWING</u>	
Prepared By:	Date:
KGW	15/05/2024
Checked By:	Date:
MM	15/05/2024

# Approved By:

Project Number:	Brick Verde Ref Number:
32/23/200	240219AP

Project Title:

PROPOSED ASPHALT PLANT, AGGREGATE SCREENING PLANT, NEW WORKSHOP, LAB AND SITE **SERVICES** 

PUBLIC WORKS QUARRY & DEPOT QUARRY ROAD HAMILTON PARISH BERMUDA

Sheet Title: PROPOSED LAB, WORKSHOP, BREAKROOM, LOCKER ROOM, PARTS STORAGE & CONTAINER OFFICE FLOOR PLANS

Sheet Number: Revisions:



# MINISTRY OF PUBLIC WORKS




# DEPARTMENT OF WORKS AND ENGINEERING

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#### DAP 1 APPLICATION DRAWINGS

# ISSUE / REVISION No. Date: 1 Issued for DAP 1 Submission 04 Jul 2024 2 Issued for DAP 1 Submission 22 Jul 2024

3 Issued for DAP 1 Submission 26 Jul 2024 4 Issued for Tender 13 Aug 2024
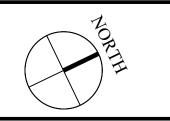
#### SCALE: 1/4" = 1'-0"

SURVEY
Prepared By:

GOVERNMENT LAND SURVEY DEPT

DESIGN

 Prepared By:
 Date:

 KGW
 15/05/2024

 Checked By:
 Date:

 MM
 15/05/2024

 DRAWING
 Date:

 Prepared By:
 Date:

 KGW
 15/05/2024

 Checked By:
 Date:

 MM
 15/05/2024

# Approved By:

Project Number: Brick Verde Ref Number: 32/23/200 240219AP

# Project Title:

PROPOSED ASPHALT PLANT, AGGREGATE SCREENING PLANT, NEW WORKSHOP, LAB AND SITE SERVICES


PUBLIC WORKS QUARRY & DEPOT QUARRY ROAD HAMILTON PARISH BERMUDA


# Sheet Title:

PROPOSED LAB, WORKSHOP, BREAKROOM, LOCKER ROOM, PARTS STORAGE & CONTAINER OFFICE REFLECTED CEILING PLANS


Revisions:

Sheet Number:

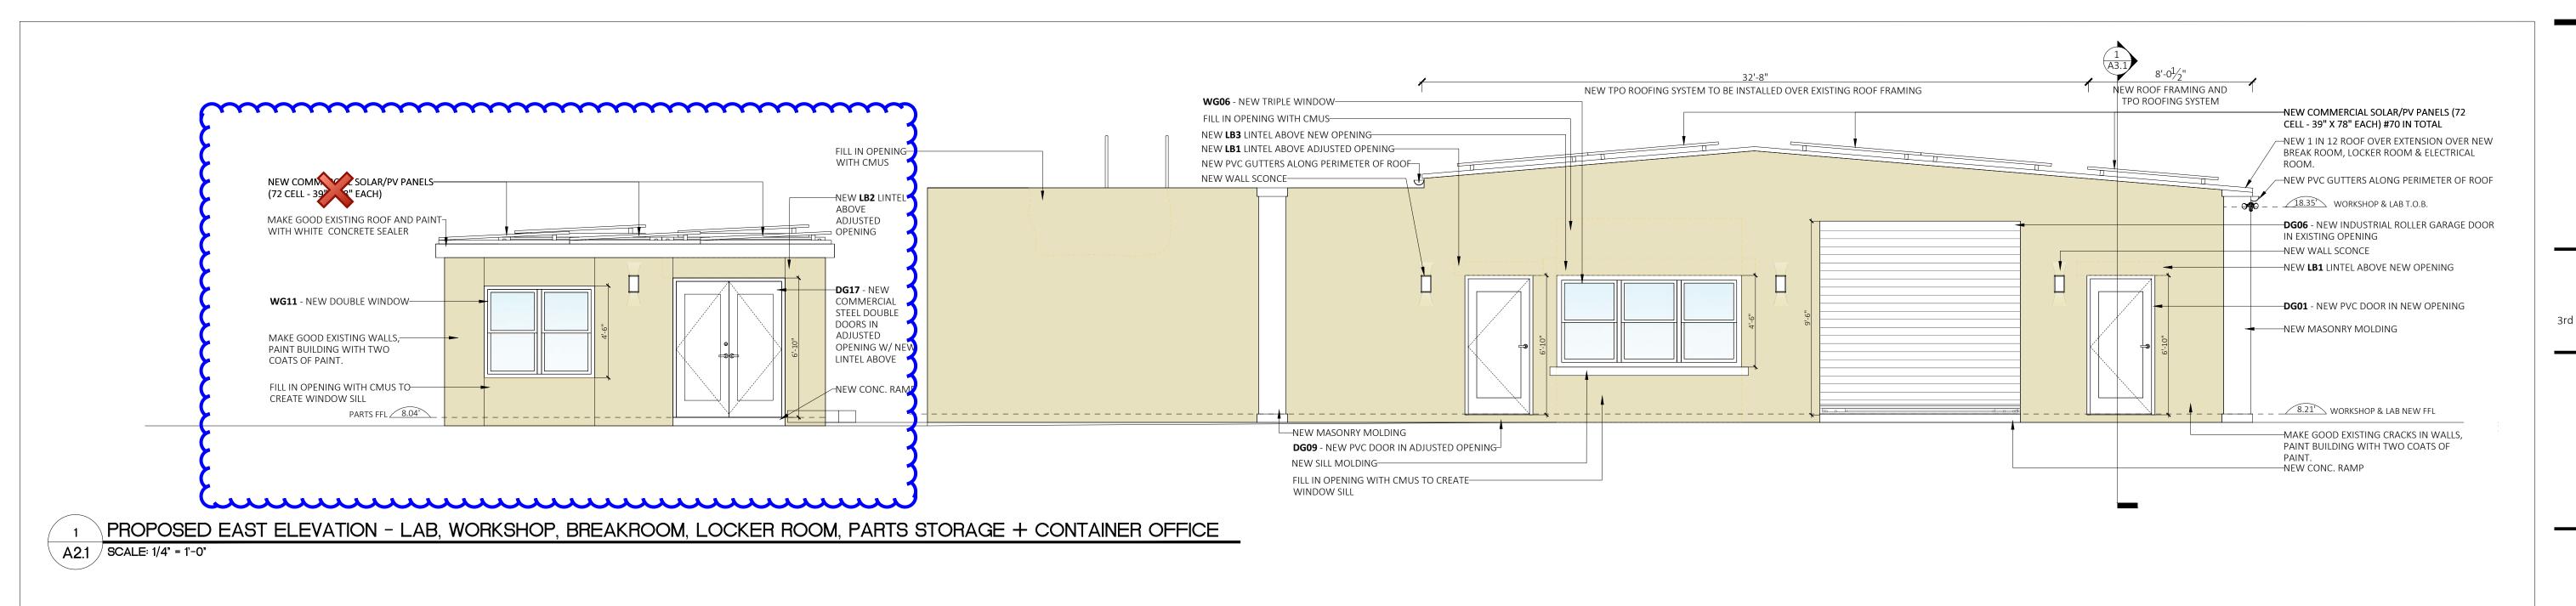

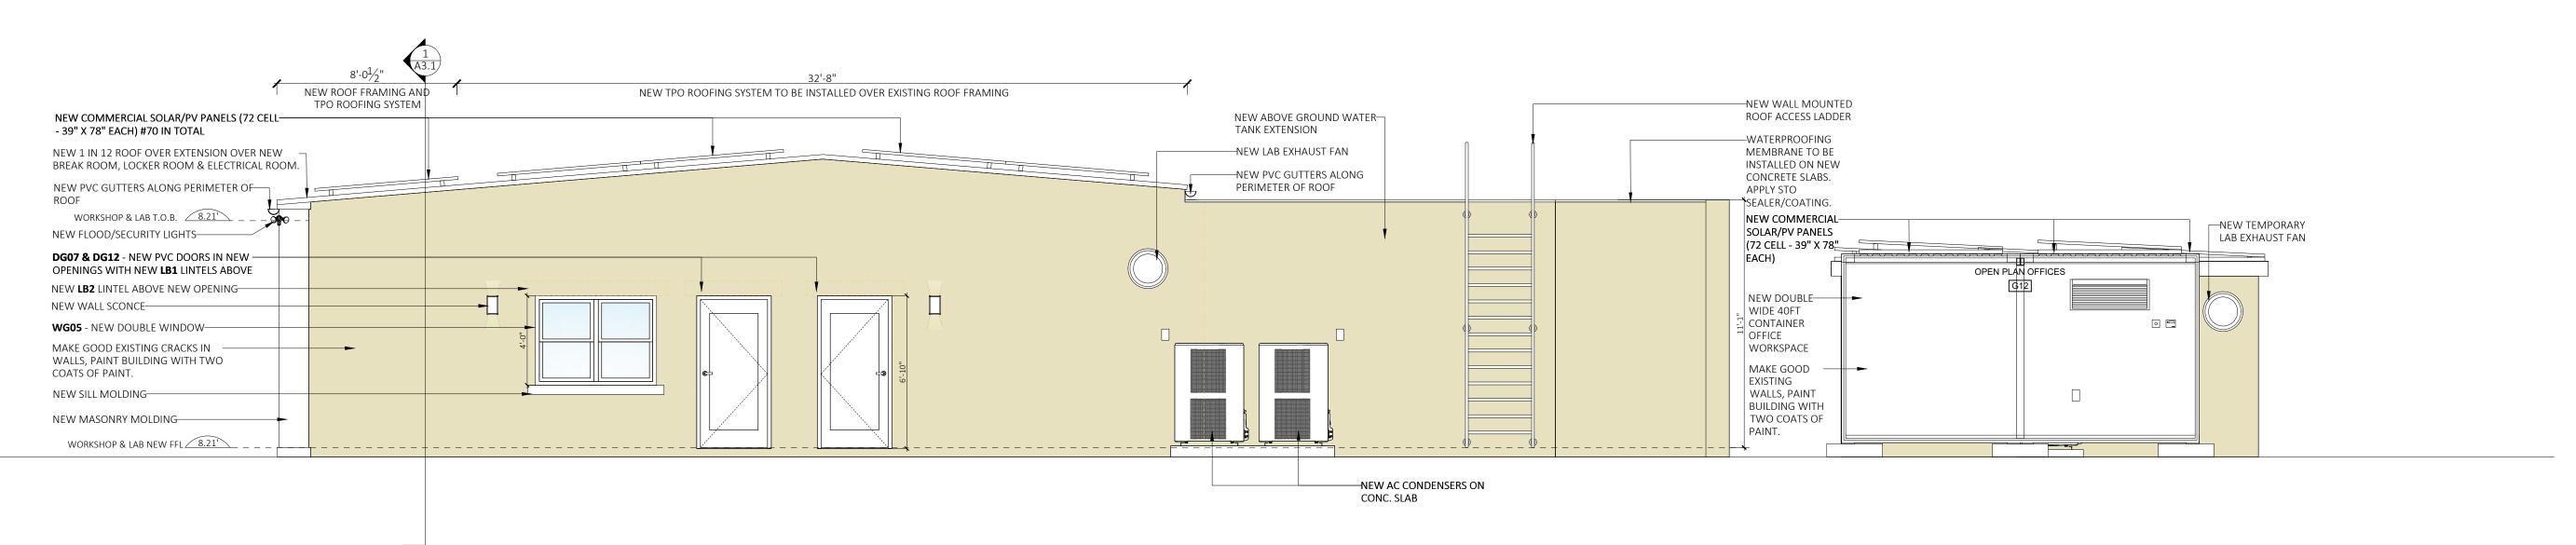

PROPOSED WEST ELEVATION - LAB, WORKSHOP, BREAKROOM, LOCKER ROOM, PARTS STORAGE + CONTAINER OFFICE

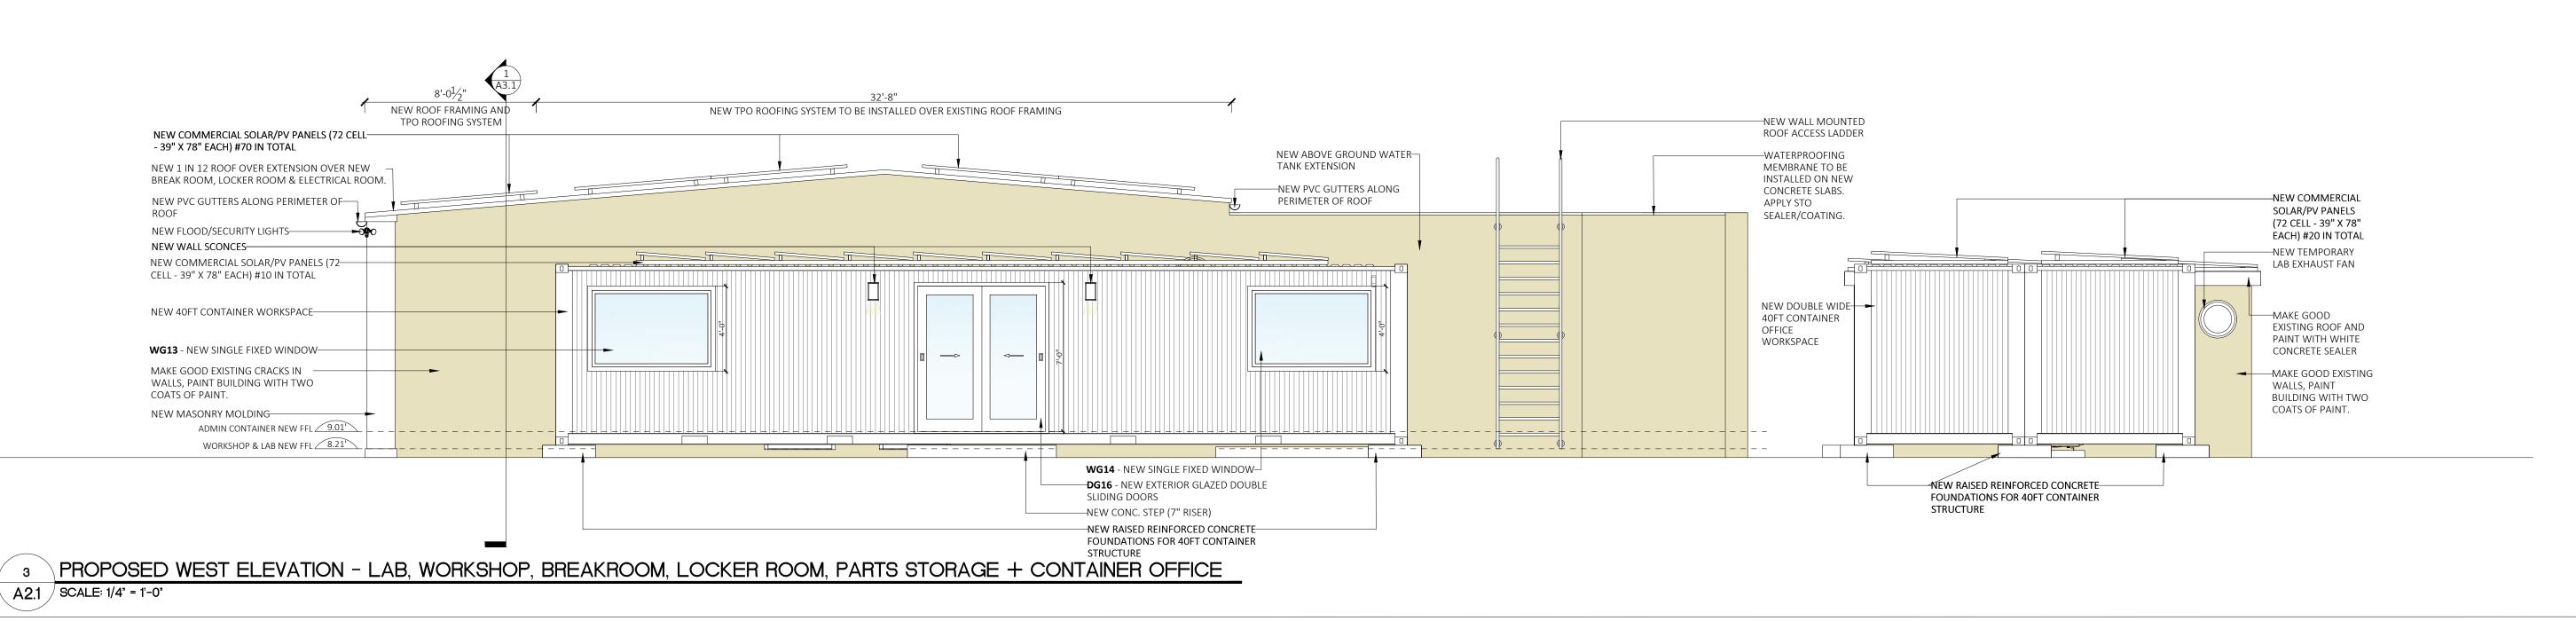

# MINISTRY OF **PUBLIC WORKS**



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#### DAP 1 APPLICATION DRAWINGS

## ISSUE / REVISION

1330	E / REVISION	
No.		Date:
1	Issued for DAP 1 Submission	26 Jun 202
2	Issued for DAP 1 Submission	22 Jul 202
3	Issued for DAP 1 Submission	26 Jul 202
4	Issued for Tender	13 Aug 202

# SCALE: 1/4" = 1'-0"

SURVEY	
Prepared By:	Date:
GOVERNMENT LAND SURVEY DEPT	
DESIGN	
Prepared By: KGW	Date: 15/05/2024
Checked By: MM	Date: 15/05/2024
DRAWING	
Prepared By: KGW	Date: 15/05/2024
Checked By:	Date: 15/05/2024

# Approved By:

Project Number:	Brick Verde Ref Number:
32/23/200	240219AP

Project Title:

#### PROPOSED ASPHALT PLANT, AGGREGATE SCREENING PLANT, NEW WORKSHOP, LAB AND SITE **SERVICES**

PUBLIC WORKS QUARRY & DEPOT QUARRY ROAD HAMILTON PARISH BERMUDA

### Sheet Title:


PROPOSED LAB, WORKSHOP, BREAKROOM, LOCKER ROOM, PARTS STORAGE & CONTAINER OFFICE -**EAST & WEST ELEVATIONS** 

Revisions:	
/4\	

A1 - 014

# **DOOR SCHEDULE**

# G01 BREAKROOM | G02 LOCKER ROOM | G03 ELECTRICAL ROOM | G04 WORKSHOP | G05 LAB | G06 SHAKER & HAMMER ROOM | G07 STORAGE | G08 PUMP ROOM |

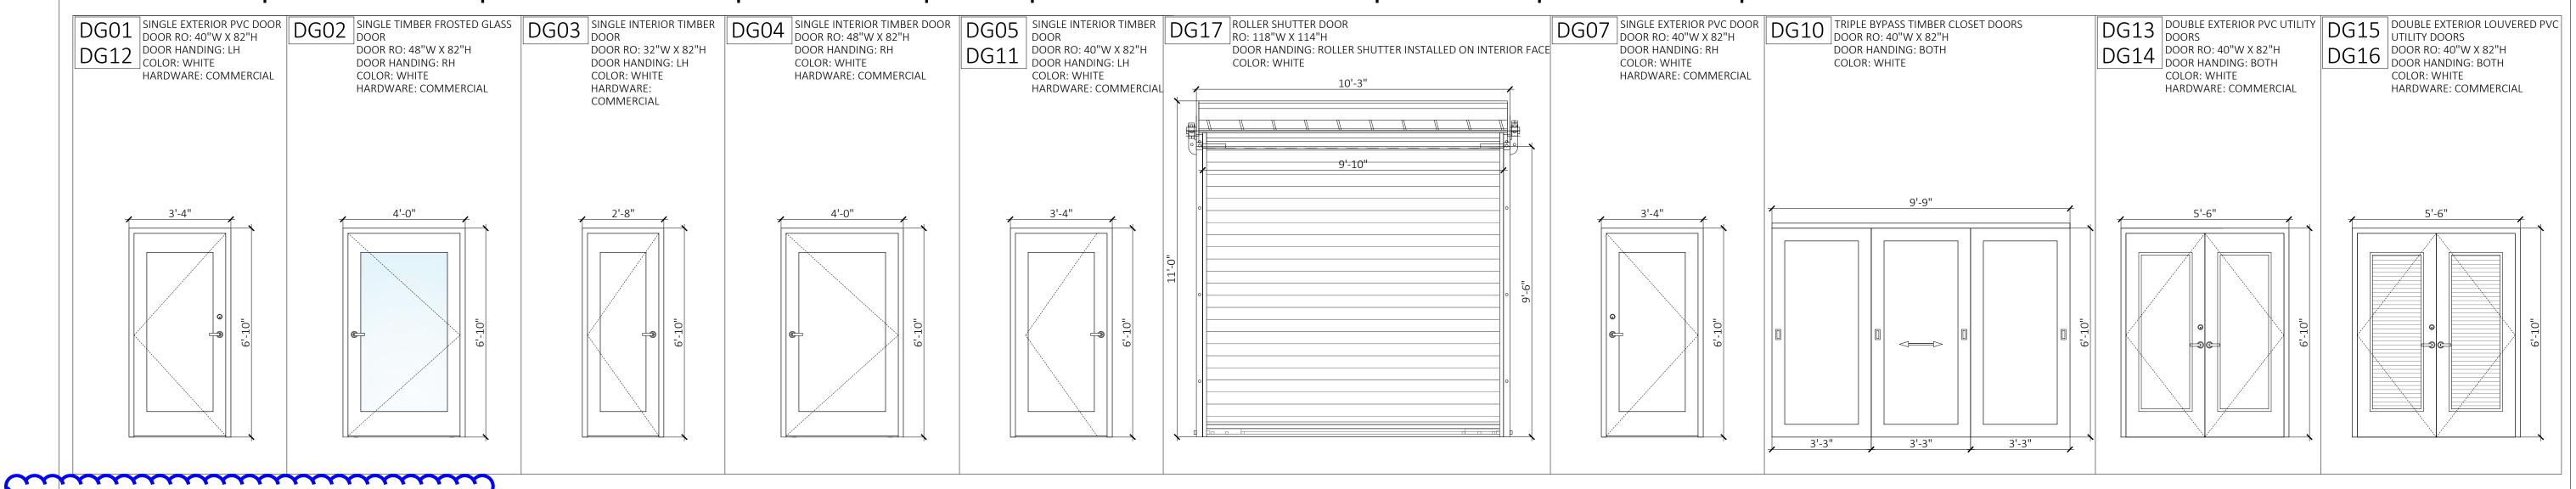

# MINISTRY OF PUBLIC WORKS



# DEPARTMENT OF WORKS AND ENGINEERING

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#### **DAP 1 APPLICATION DRAWINGS**

No.		Date:
1	Issued for Tender	09 Aug 202
2	Issued for Tender	13 Aug 202

SCALE: 3/8" = 1'-0"	
SURVEY Prepared By: GOVERNMENT LAND SURVEY DEPT	Date:
DESIGN	
Prepared By:	Date:
KGW	15/05/2024
Checked By:	Date:
MM	15/05/2024
DRAWING	
Prepared By:	Date:
KGW	15/05/2024
Checked By:	Date:
MM	15/05/2024

# Approved By:

Project Number: Brick Verde Ref Number: 32/23/200 240219AP

## Project Title:

SCHEDULES


PROPOSED ASPHALT PLANT, AGGREGATE SCREENING PLANT, NEW WORKSHOP, LAB AND SITE SERVICES

PUBLIC WORKS QUARRY & DEPOT QUARRY ROAD HAMILTON PARISH

Sheet Title:
PROPOSED DOOR & WINDOW

# Revisions: Sheet Number: A4


# G10 PARTS STORAGE / TEMPORARY LAB

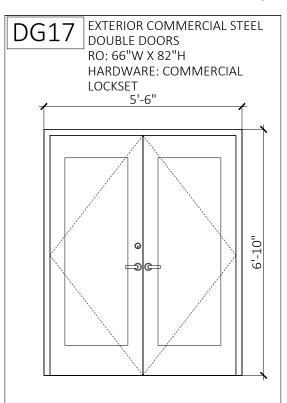

## **G11 OFFICES**




## **G12 OPEN PLAN OFFICES**

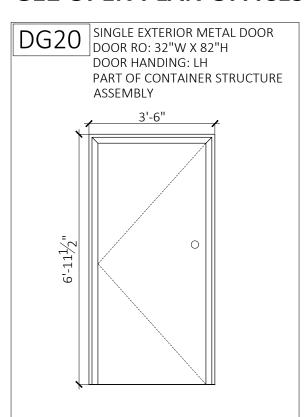

# WINDOW SCHEDULE

mummum

# G01 BREAKROOM | G02 LOCKER ROOM | G03 ELECTRICAL ROOM | G04 WORKSHOP | G05 LAB

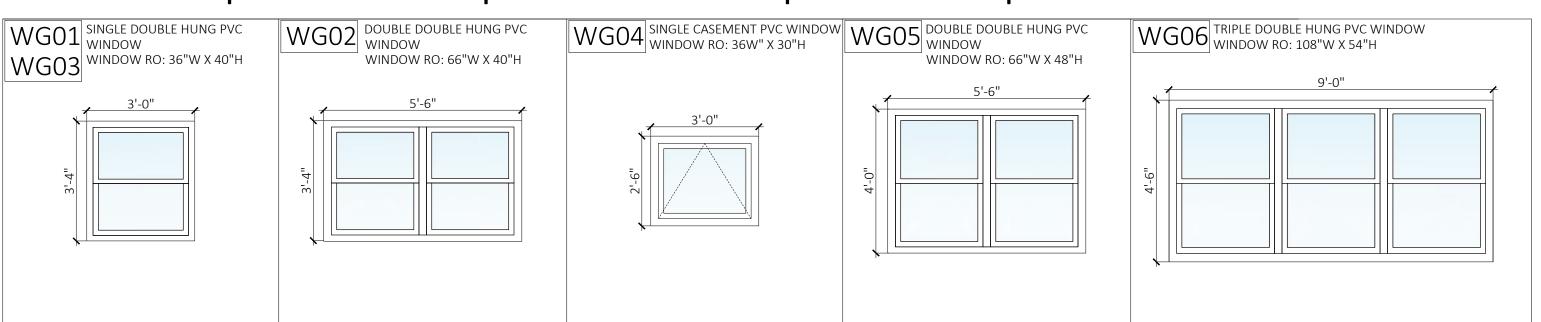


# WG07 HOPPER PVC WINDOW WINDOW RO: 36"W X 18"H WG08 WG09 WG10 3'-0" WG07 HOPPER PVC WINDOW WINDOW (IMPACT RESISTANT) WINDOW RO: 66"W X 54"H 5'-6"

 $\alpha$ 

**G10 PARTS STORAGE / TEMPORARY LAB** 

### **G11 OFFICES**

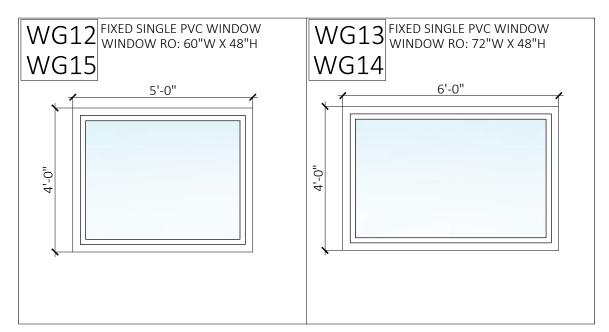


# **G12 OPEN PLAN OFFICES**

WG17 WINDOW RO: 39"W X 39"H PART OF CONTAINER STRUCTURE ASSEMBLY 3'-3" WG19 WG20 WG21 WG22
WG18 3'-3" WG19 WG20 WG21 7 7 7 7 7 7 7 7 7 7 7 7 7 7 7 7 7 7 7
WG20 WG21 5
WG21 -
WG22

1 PROPOSED DOOR + WINDOW SCHEDULES

A4.1 SCALE: 3/8" = 1'-0"

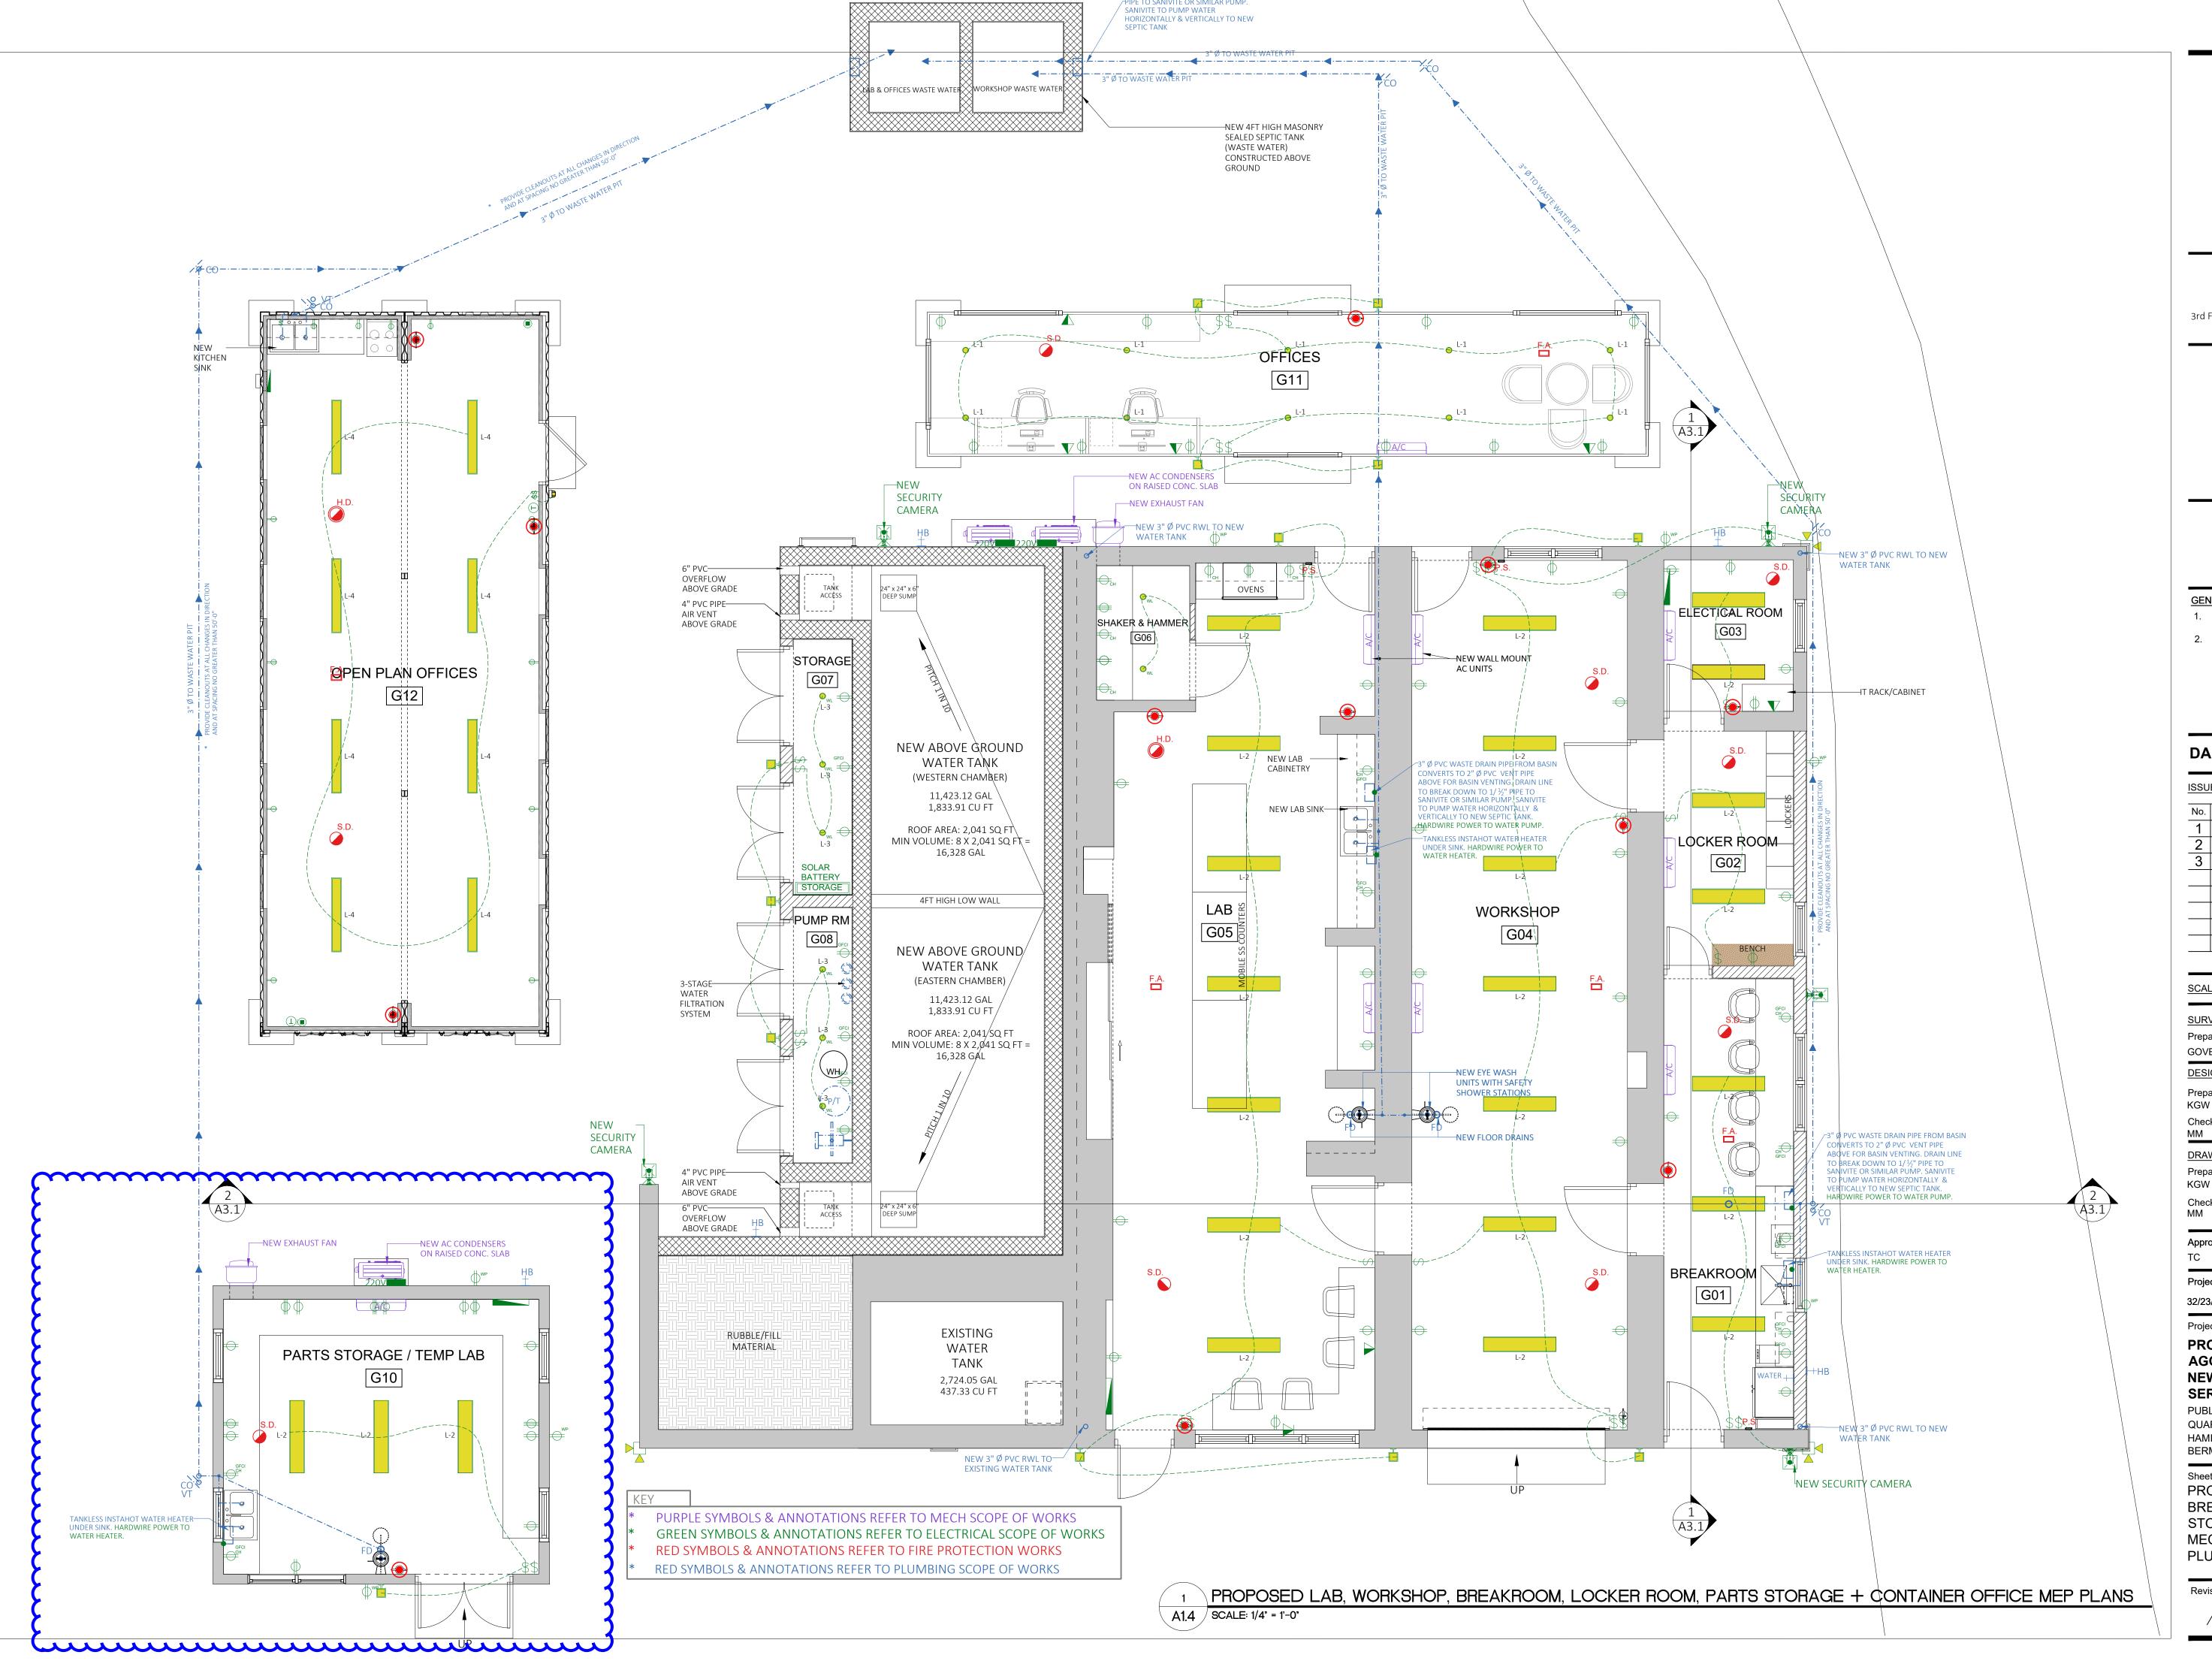

MINISTRY OF **PUBLIC WORKS** 



#### DEPARTMENT OF WORKS AND ENGINEERING

Government Administration Building, 3rd Floor | 56 Church Street | Hamilton, Bermuda HM12

Tel: (441) 501-3005



P.O. Box HM 428, Hamilton, Bermuda HM BX Tel: +1 441 707 0700 Email: info@brickverde.com

Web: www.brickverde.com



#### **GENERAL NOTES**

- 1. DO NOT SCALE THE DRAWINGS
- 2. THE CONTRACTOR SHALL VERIFY ALL DIMENSIONS ON SITE AND REPORT ANY DISCREPANCIES TO THE OWNERS REPRESENTATIVE BEFORE PROCEEDING WITH THE WORKS.

#### **DAP 1 APPLICATION DRAWINGS**

# ISSUE / REVISION 1 Issued for DAP 1 Submission 22 Jul 2024 2 Issued for DAP 1 Submission 26 Jul 2024 3 Issued for Tender 13 Aug 2024

Date:
-

Prepared By: KGW 15/05/2024 Checked By: Date: 15/05/2024 DRAWING Prepared By: Date: KGW 15/05/2024 Checked By: 15/05/2024

Approved By:

Project Number: Brick Verde Ref Number: 32/23/200 240219AP

Project Title:

PROPOSED ASPHALT PLANT, AGGREGATE SCREENING PLANT, NEW WORKSHOP, LAB AND SITE **SERVICES** 


PUBLIC WORKS QUARRY & DEPOT QUARRY ROAD HAMILTON PARISH BERMUDA

Sheet Title:

PROPOSED LAB, WORKSHOP, BREAKROOM, LOCKER ROOM, PARTS STORAGE & CONTAINER OFFICE MECHANICAL, ELECTRICAL, PLUMBING

Revisions:

Sheet Number:

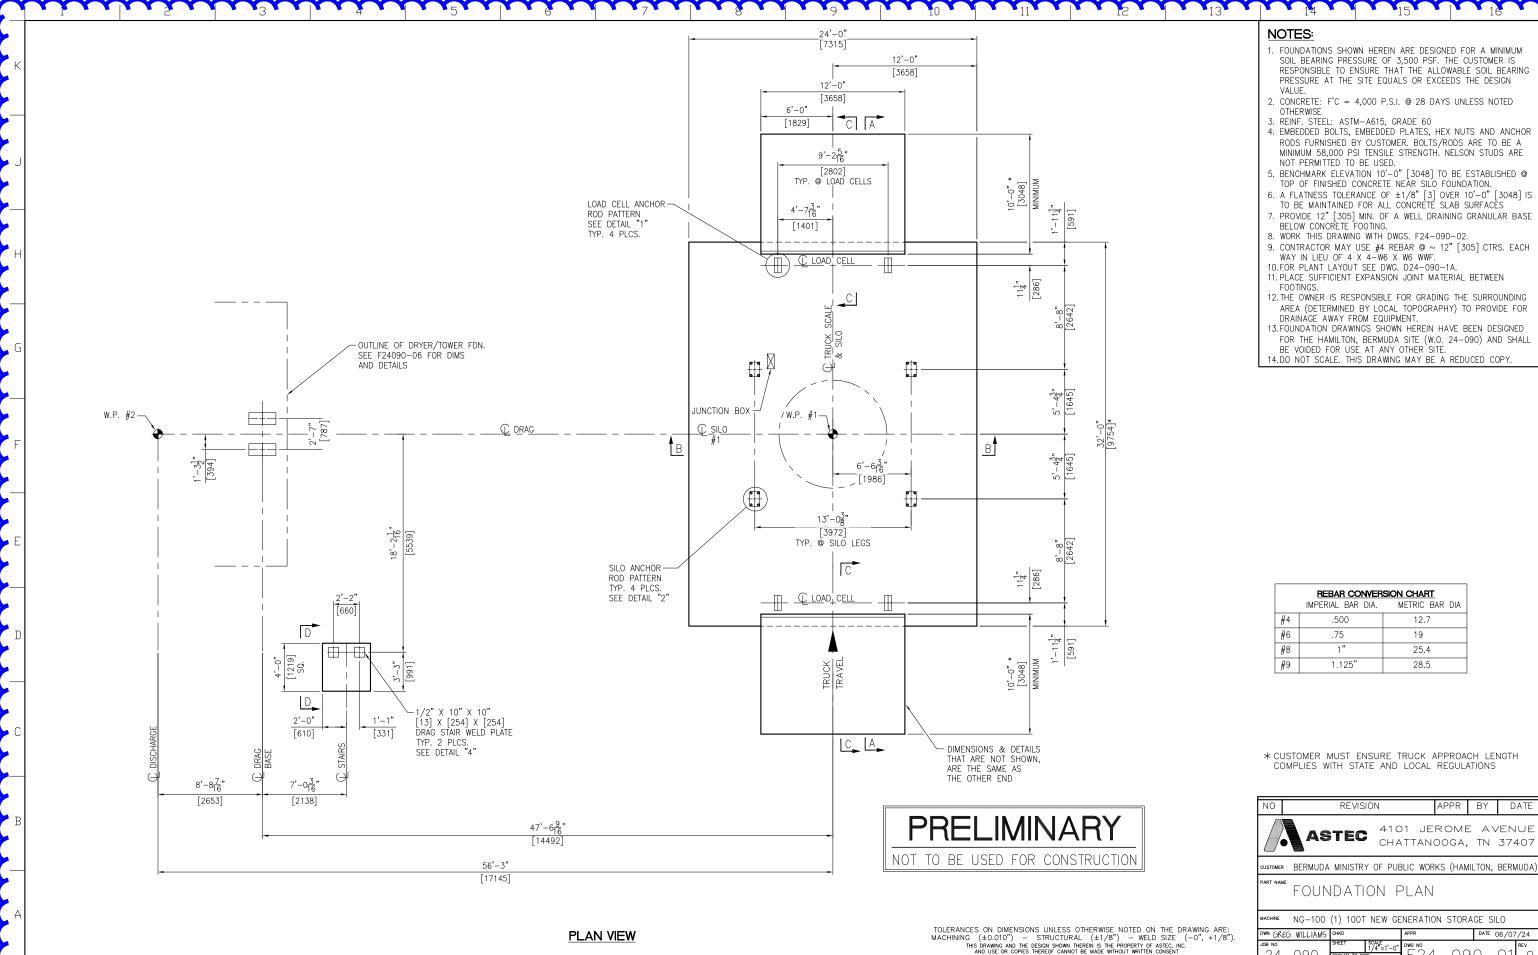

- 1. FOUNDATIONS SHOWN HEREIN ARE DESIGNED FOR A MINIMUM SOIL BEARING PRESSURE OF 3,500 PSF. THE CUSTOMER IS RESPONSIBLE TO ENSURE THAT THE ALLOWABLE SOIL BEARING PRESSURE AT THE SITE EQUALS OR EXCEEDS THE DESIGN
- 2. CONCRETE: F'C = 4,000 P.S.I. @ 28 DAYS UNLESS NOTED
- OTHERWISE

  3. REINF. STEEL: ASTM—A615, GRADE 60

  4. EMBEDDED BOLTS, EMBEDDED PLATES, HEX NUTS AND ANCHOR RODS FURNISHED BY CUSTOMER. BOLTS/RODS ARE TO BE A MINIMUM 58,000 PSI TENSILE STRENGTH. NELSON STUDS ARE

- 10.FOR PLANT LAYOUT SEE DWG. D24-090-1A.
- 11. PLACE SUFFICIENT EXPANSION JOINT MATERIAL BETWEEN
- 12. THE OWNER IS RESPONSIBLE FOR GRADING THE SURROUNDING AREA (DETERMINED BY LOCAL TOPOGRAPHY) TO PROVIDE FOR
- DRAINAGE AWAY FROM EQUIPMENT.


  13.FOUNDATION DRAWINGS SHOWN HEREIN HAVE BEEN DESIGNED
  FOR THE HAMILTON, BERMUDA SITE (W.O. 24–090) AND SHALL
  BE VOIDED FOR USE AT ANY OTHER SITE.


  14.DO NOT SCALE. THIS DRAWING MAY BE A REDUCED COPY.


	REBAR CONVERSION CHART				
	IMPERIAL BAR DIA.	METRIC BAR DIA			
#4	.500	12.7			
#6	.75	19			
#8	1"	25.4			
#9	1.125"	28.5			


\*CUSTOMER MUST ENSURE TRUCK APPROACH LENGTH COMPLIES WITH STATE AND LOCAL REGULATIONS


NO	REVISION			APPR	BY	DATE	
	AS	TEC					ENUE 37407
CUSTOMER	BERMUDA	MINISTRY	OF PUE	LIC WOR	KS (HAM	IILTON,	BERMUDA)
PART NAME	FOUN	IDATI	ON F	PLAN			
MACHINE	NG-100	(1) 100T	NEW GE	NERATIC	N STOR	AGE SII	LO
DWN GREO	5 WILLIAMS	CHKD		APPR		DATE (	06/07/24
JOB NO		SHEET	SCALE	DWC NO		-	DEV/

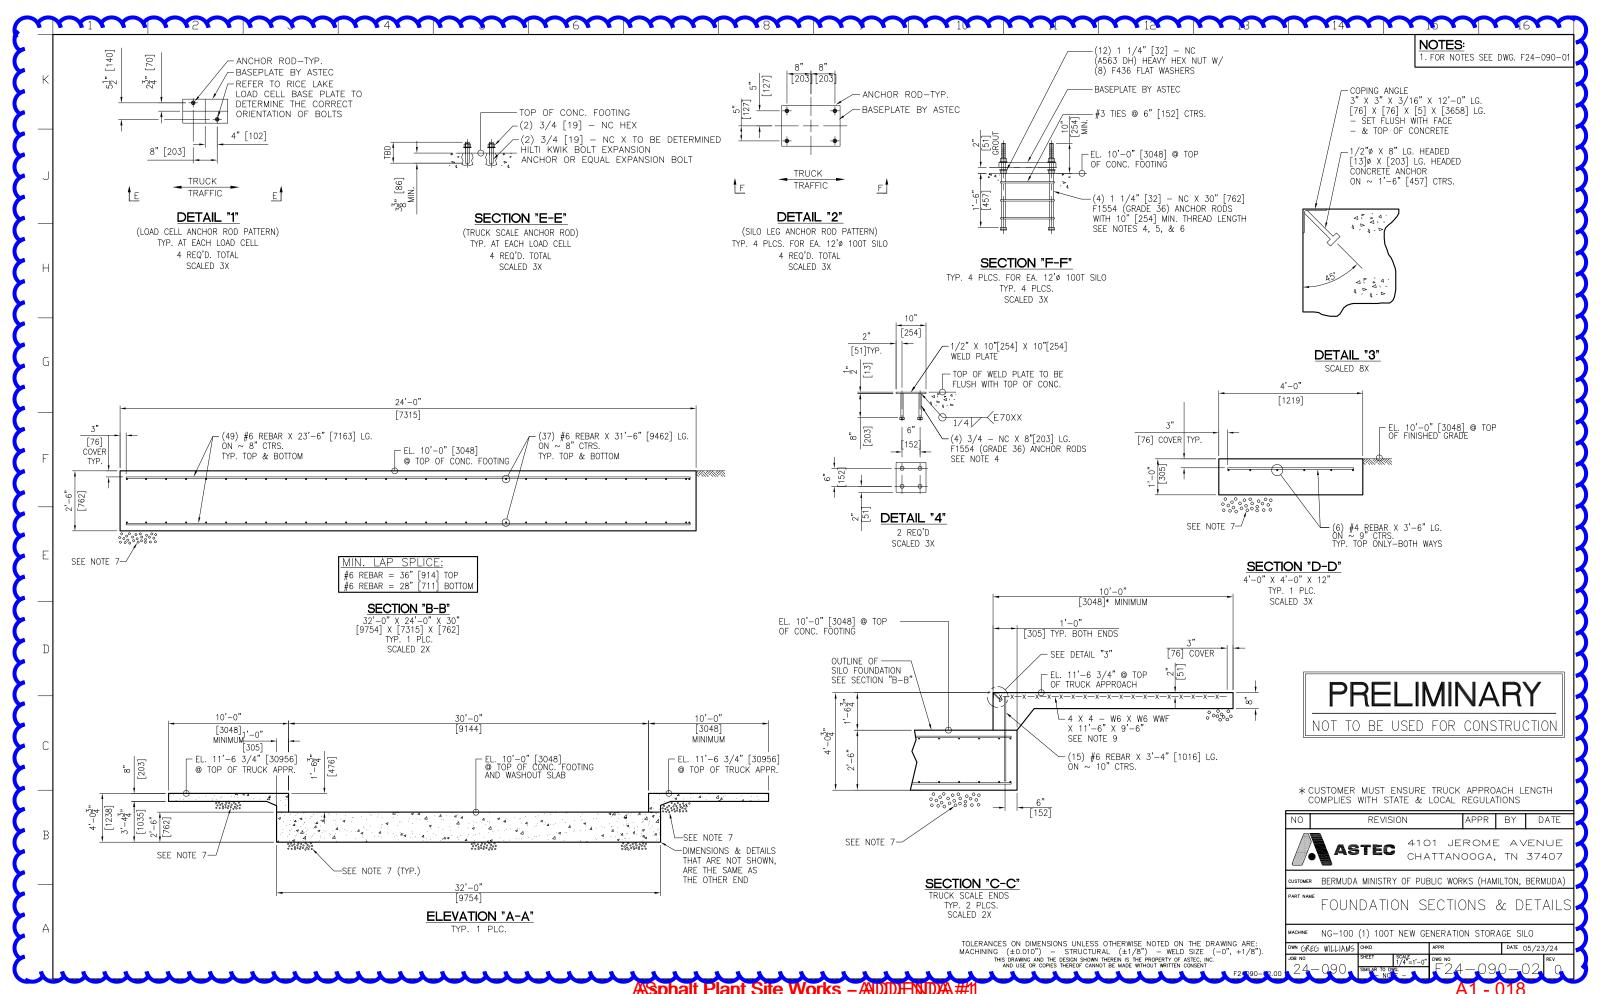

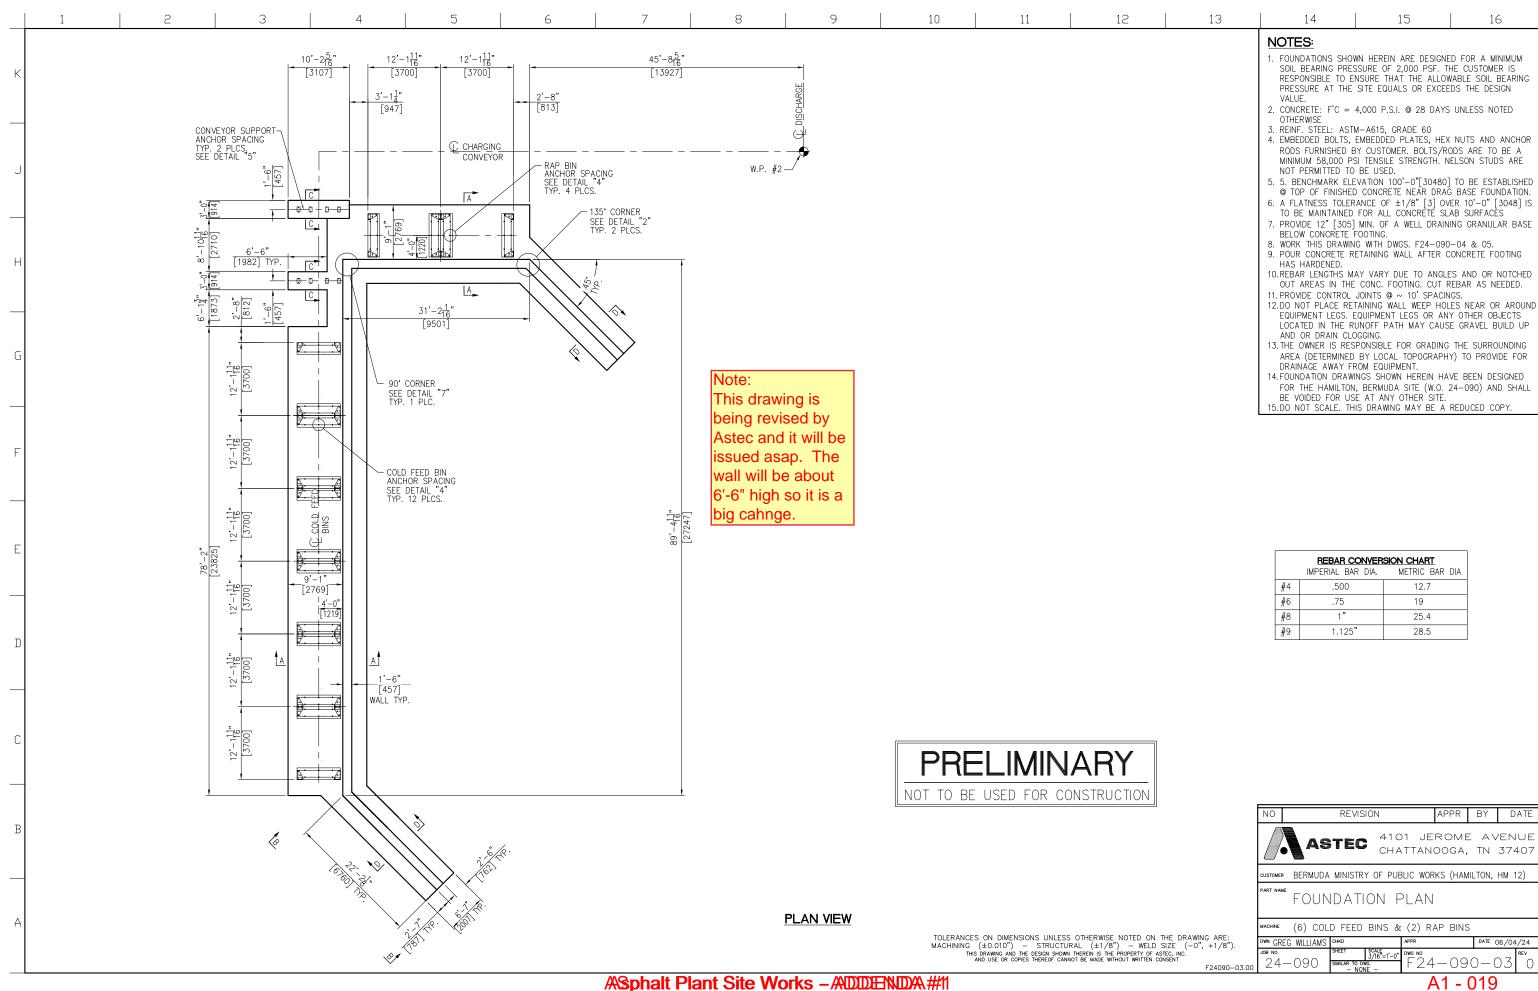

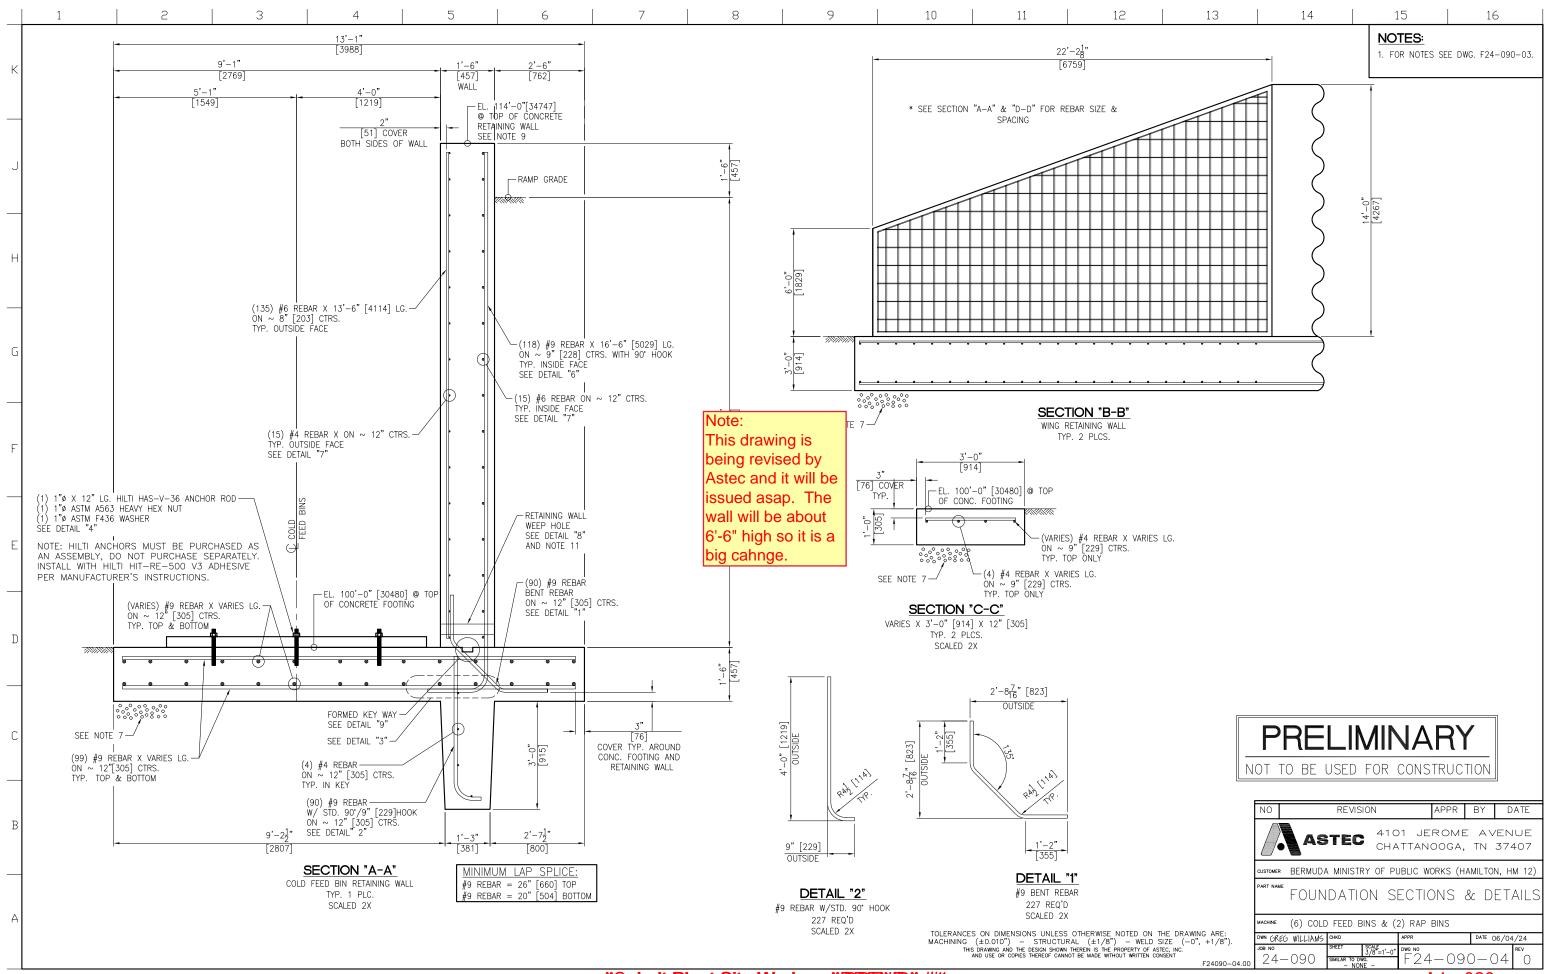

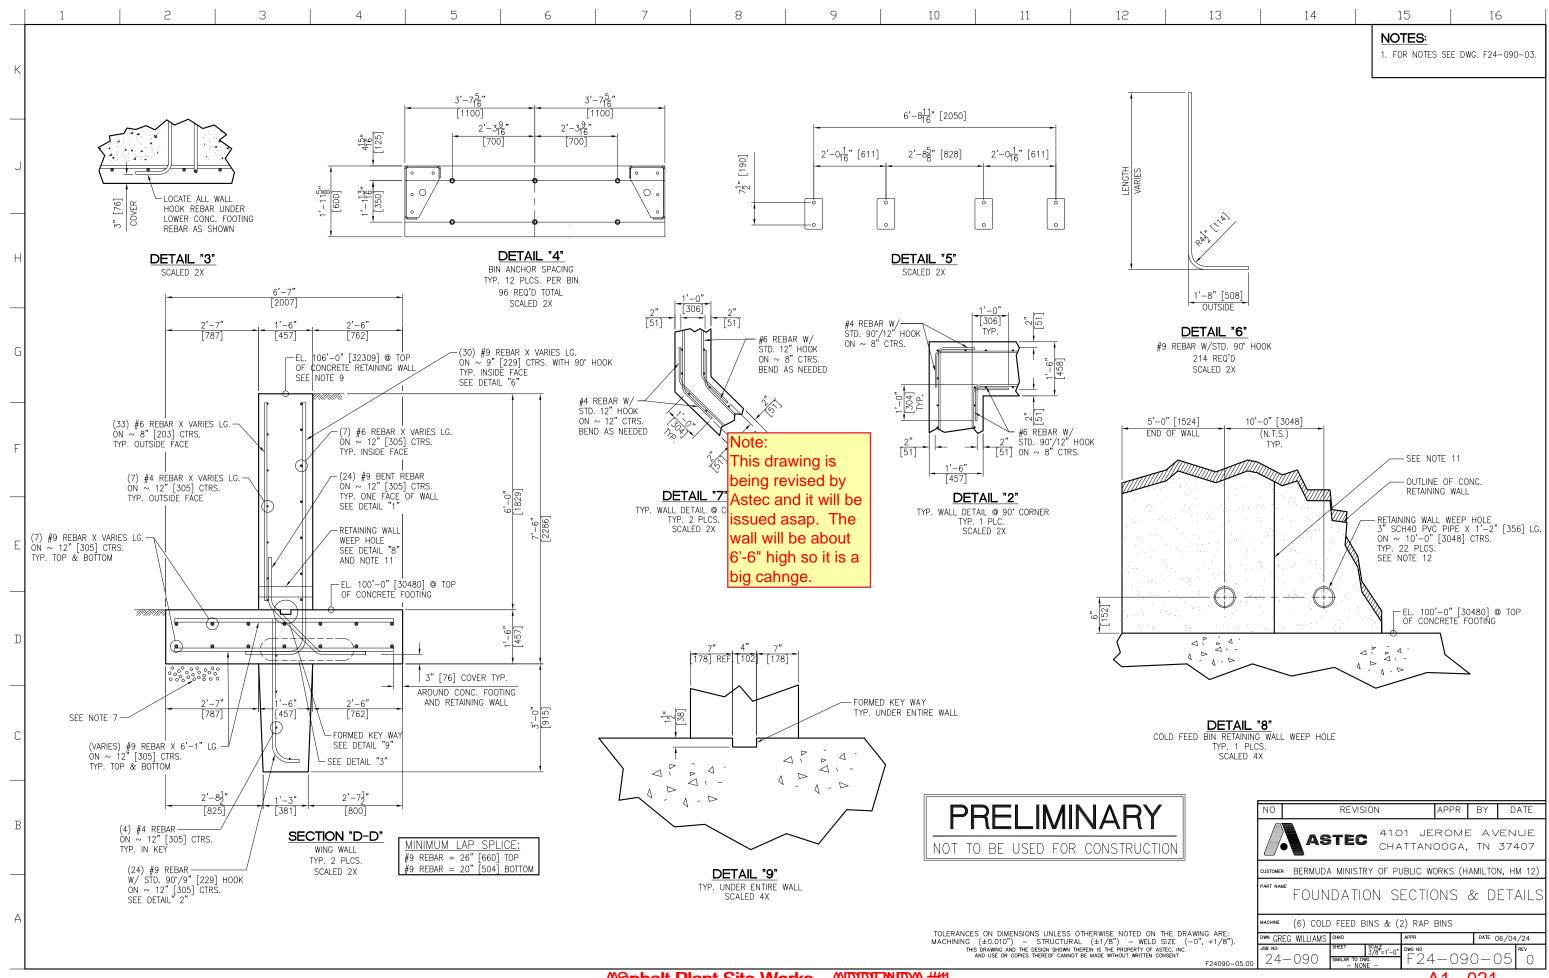

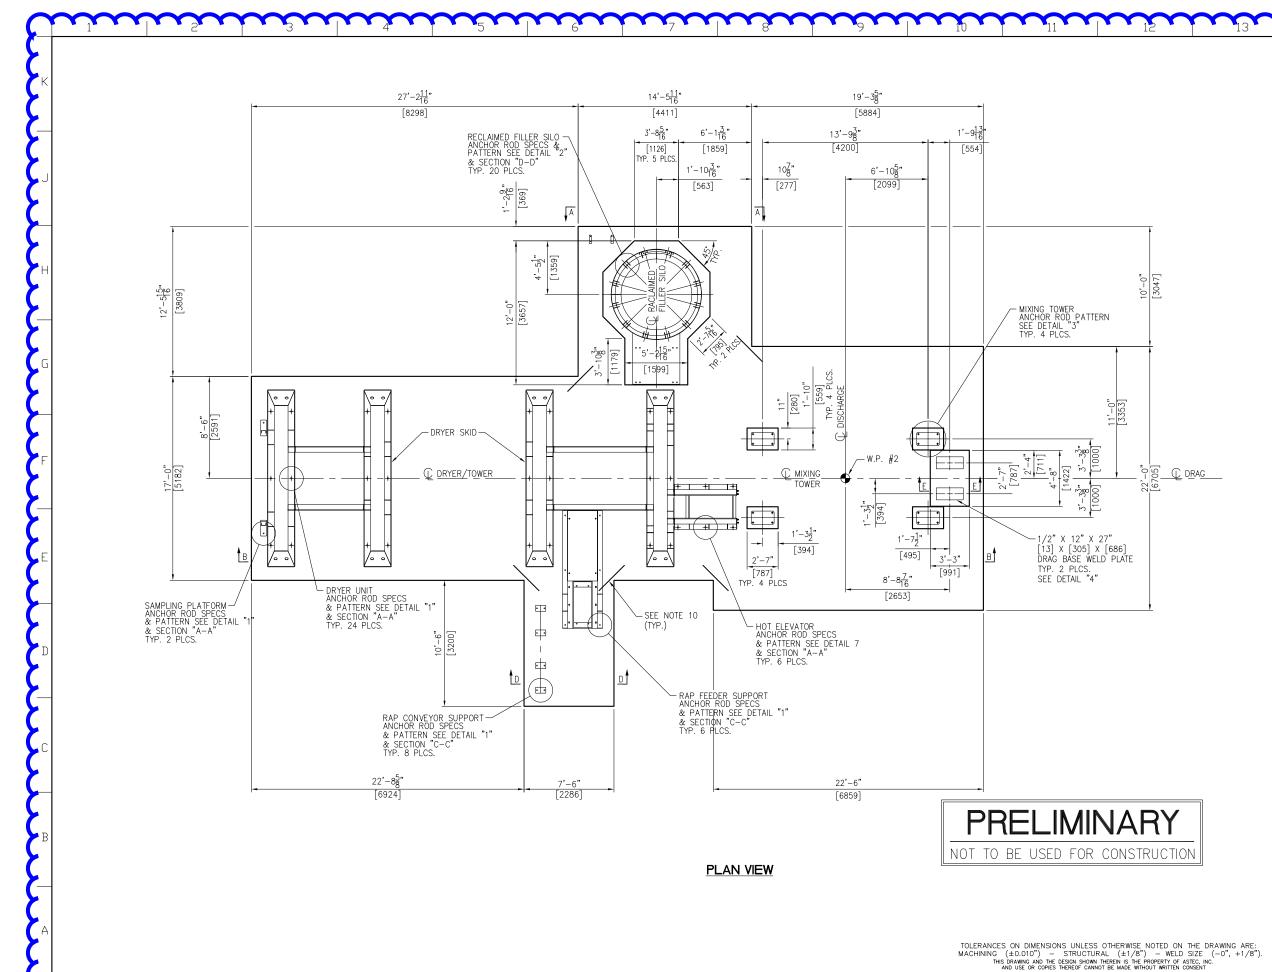

- 1. FOUNDATIONS SHOWN HEREIN ARE DESIGNED FOR A MINIMUM SOIL BEARING PRESSURE OF 3,500 PSF. THE CUSTOMER IS RESPONSIBLE TO ENSURE THAT THE ALLOWABLE SOIL BEARING PRESSURE AT THE SITE EQUALS OR EXCEEDS THE DESIGN
- 2. CONCRETE: F'C = 4,500 P.S.I. @ 28 DAYS UNLESS NOTED OTHERWISE
- 3. REINF. STEEL: ASTM-A615, GRADE 60
- 4. EMBEDDED BOLTS, EMBEDDED PLATES, HEX NUTS AND ANCHOR RODS FURNISHED BY CUSTOMER. BOLTS/RODS ARE TO BE A MINIMUM 58,000 PSI TENSILE STRENGTH. NELSON STUDS ARE NOT PERMITTED TO BE USED.

- NOT PERMITTED TO BE USED.

  5. BENCHMARK ELEVATION 10'-0"[3048] TO BE ESTABLISHED ® TOP OF FINISHED CONCRETE NEAR SILO FOUNDATION.

  6. A FLATNESS TOLERANCE OF ±1/8" [3] OVER 10'-0" [3048] IS TO BE MAINTAINED FOR ALL CONCRETE SLAB SURFACES


  7. PROVIDE 12" [305] MIN. OF A WELL DRAINING GRANULAR BASE BELOW CONCRETE FOOTING.
- 8. WORK THIS DRAWING WITH DWGS. F24-090-07 & 07A. 9. REBAR LENGTHS MAY VARY DUE TO ANGLES AND OR NOTCHED
- OUT AREAS IN THE CONC. FOOTING. CUT REBAR AS NEEDED.
- 10.PLACE #4 REBAR X 36" LG. AT EACH OFFSET CORNER OF CONC. FOOTING. MAINTAIN A MIN. OF 3" IN. COVER ALL
- 11. POUR CONC. PEDESTALS AFTER CONC. FOOTING HAS HARDENED.
  12. THE OWNER IS RESPONSIBLE FOR GRADING THE SURROUNDING AREA (DETERMINED BY LOCAL TOPOGRAPHY) TO PROVIDE FOR DRAINÀGE AWAY FROM EQUIPMENT.
- 13. FOUNDATION DRAWINGS SHOWN HEREIN HAVE BEEN DESIGNED FOR THE HAMILTON, BERMUDA SITE (W.O. 24-090) AND SHALL BE VOIDED FOR USE AT ANY OTHER SITE.


  14.DO NOT SCALE. THIS DRAWING MAY BE A REDUCED COPY.


REBAR CONVERSION CHART					
	IMPERIAL BAR DIA.	METRIC BAR DIA			
#4	.500	12.7			
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#9	1.125"	28.5			


REVISION APPR BY DATE 4101 JEROME AVENUE CHATTANOOGA, TN 37407 USTOMER BERMUDA MINISTRY OF PUBLIC WORKS (HAMILTON, BERMUDA) FOUNDATION PLAN


DRYER/TOWER, RECLAIMED FILLER SILO, & MISC. EQUIPMENT

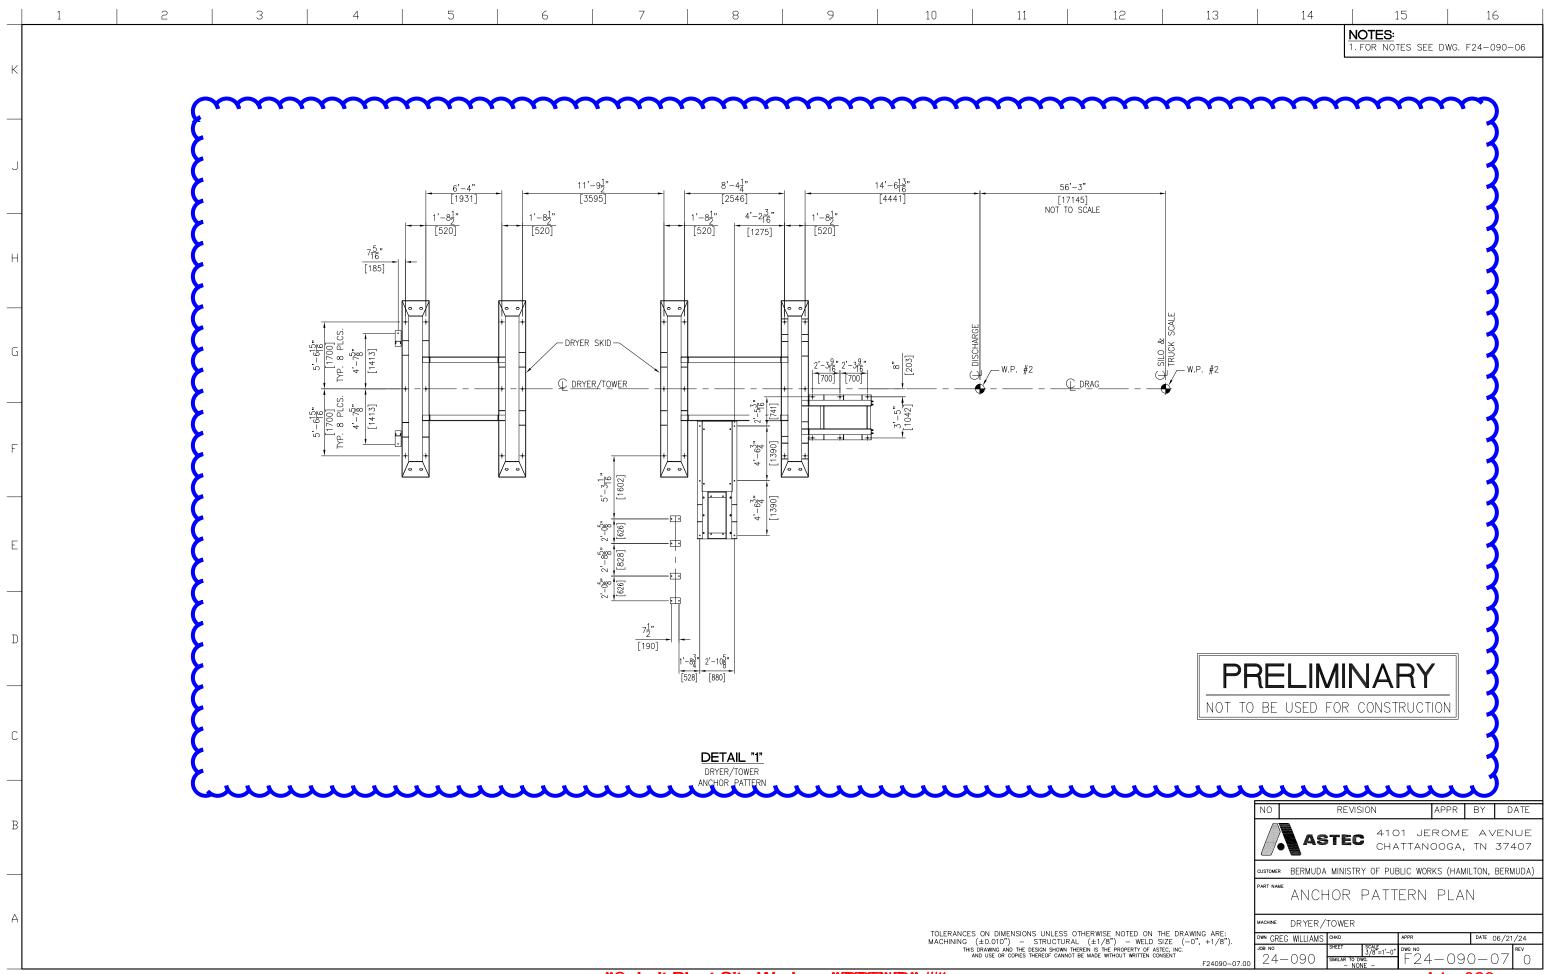


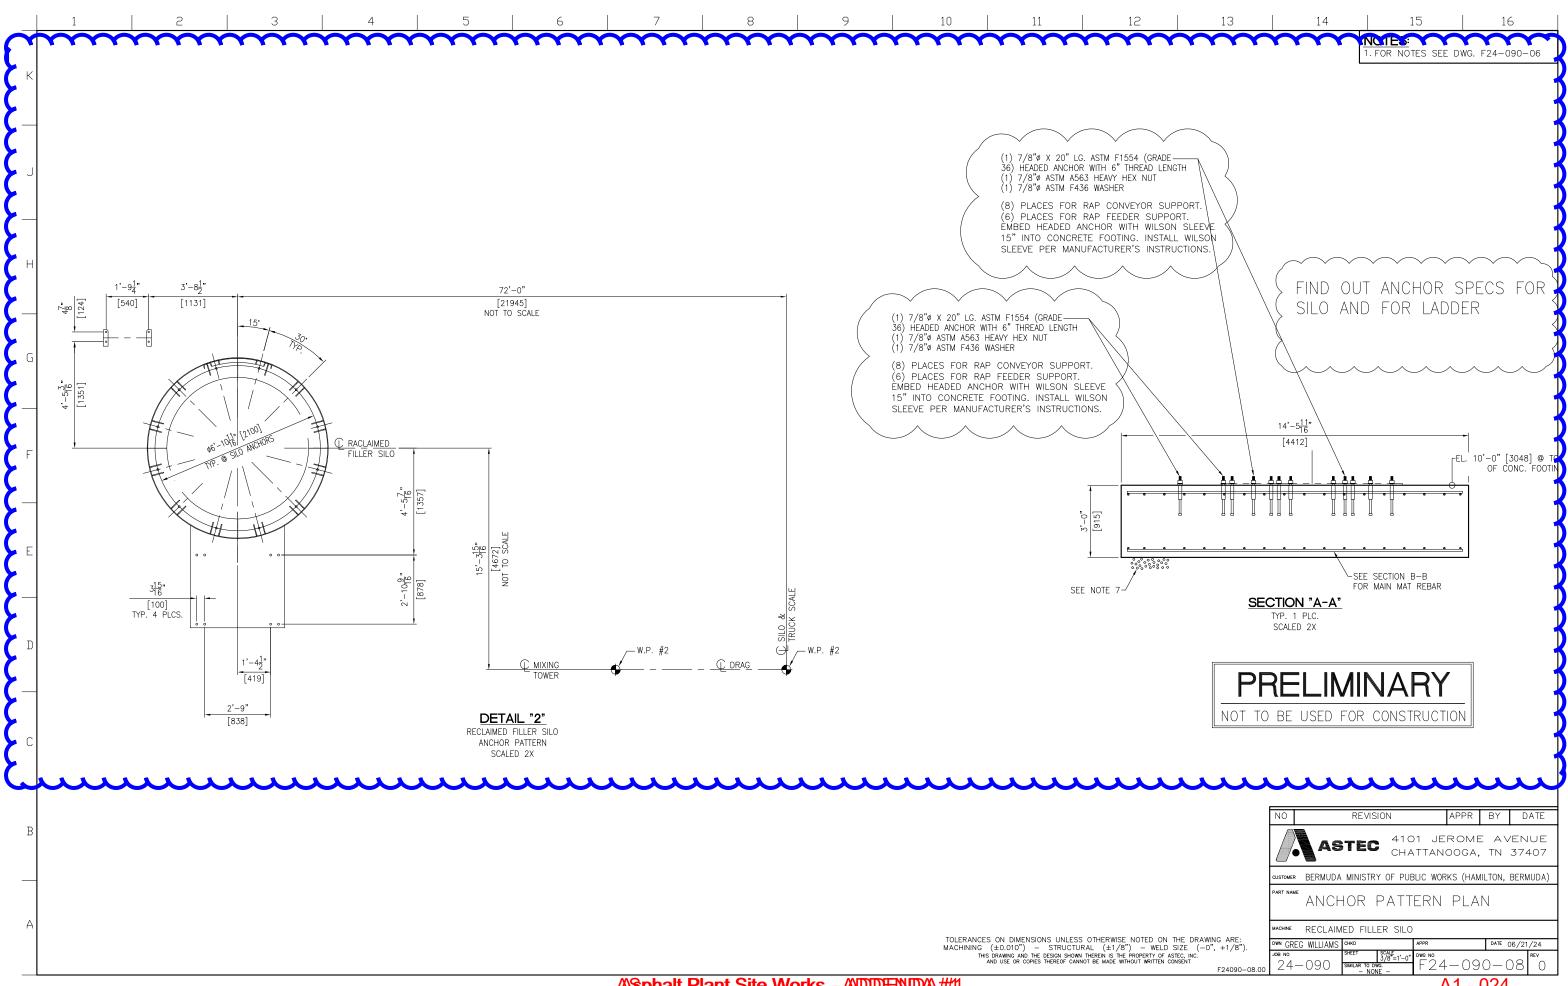

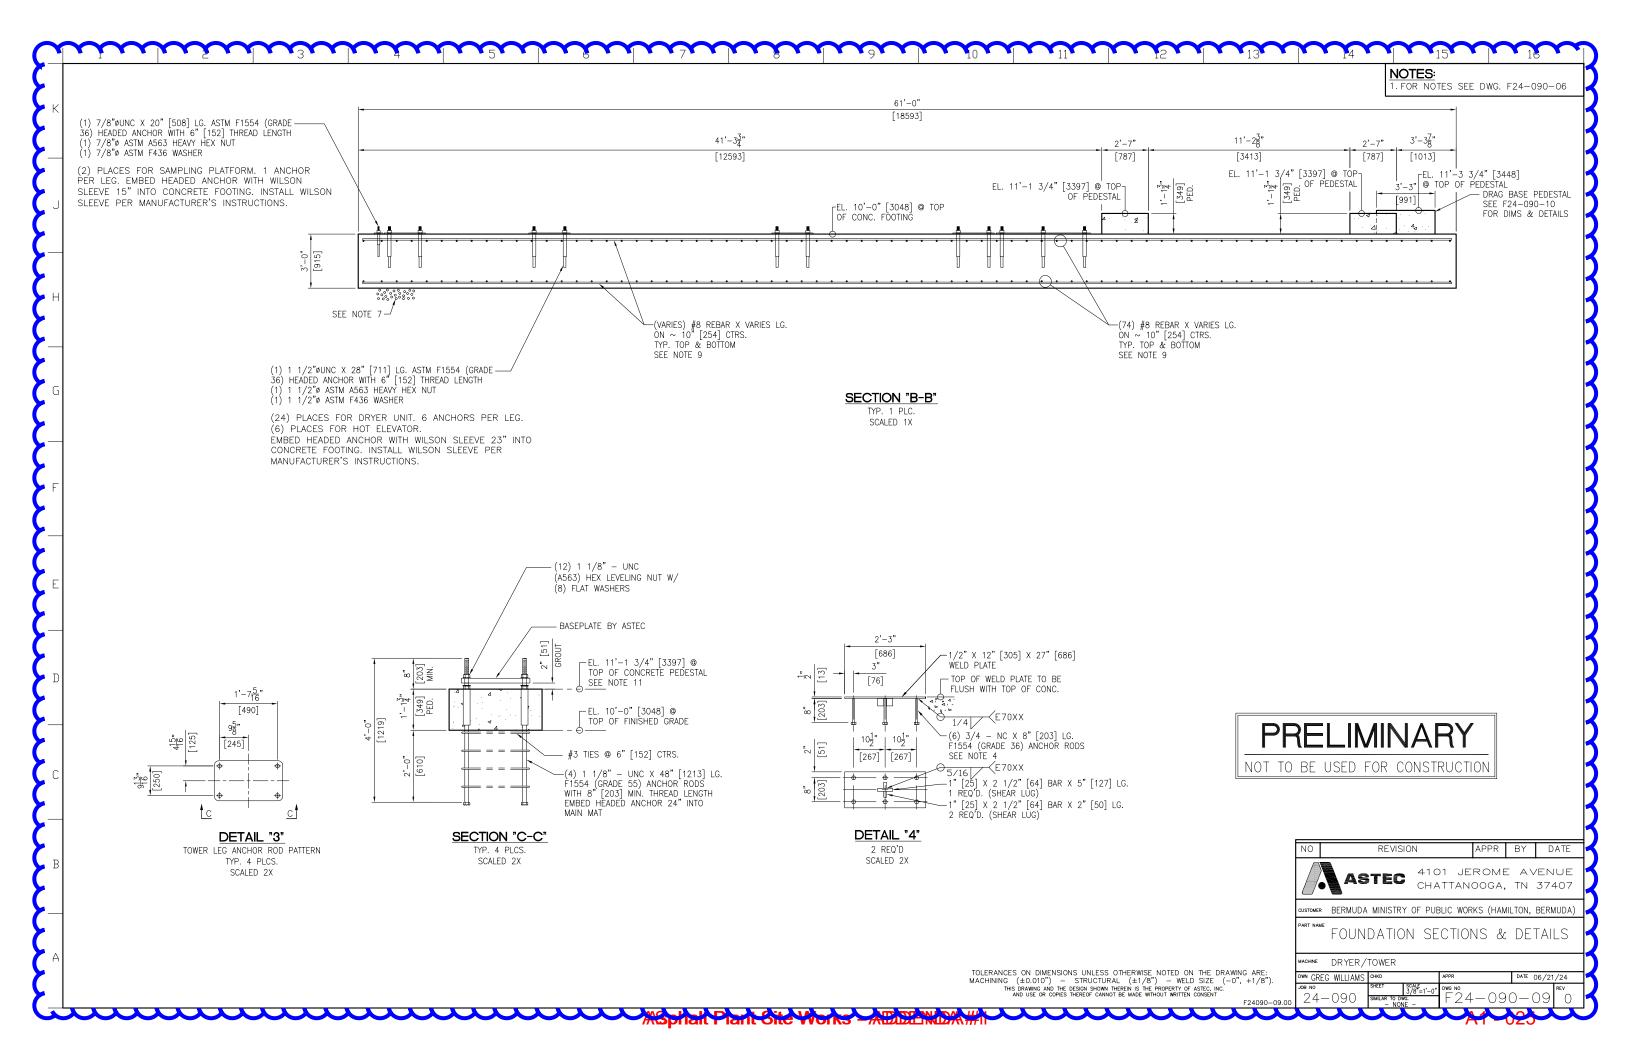

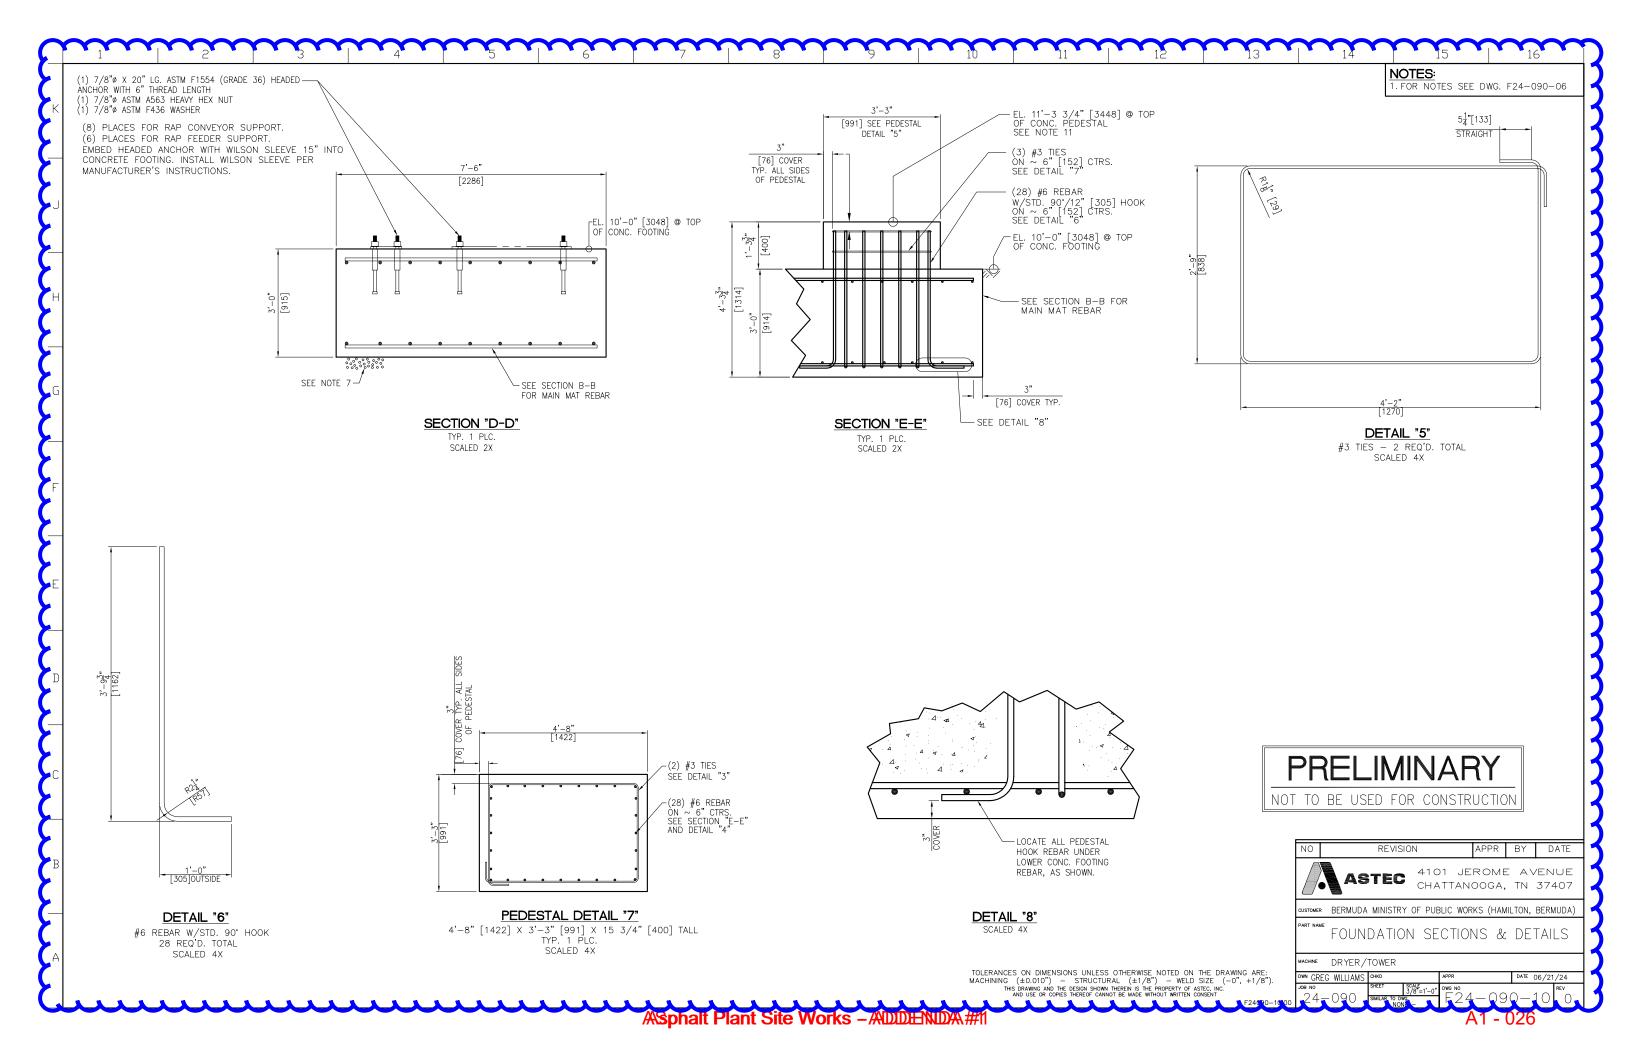

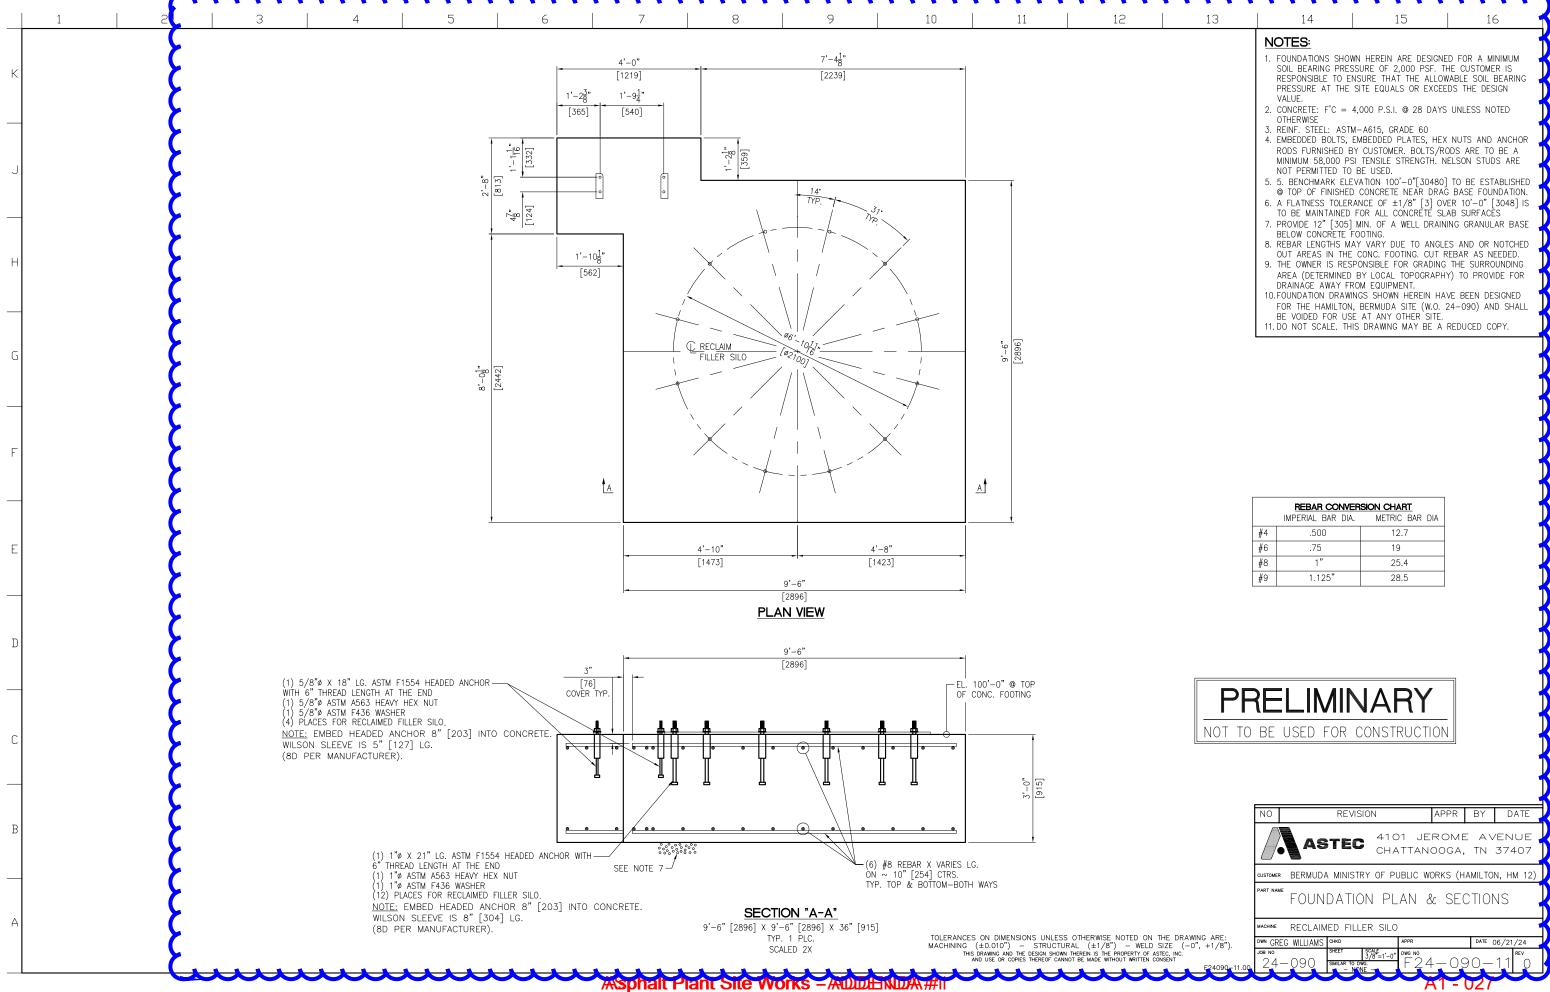

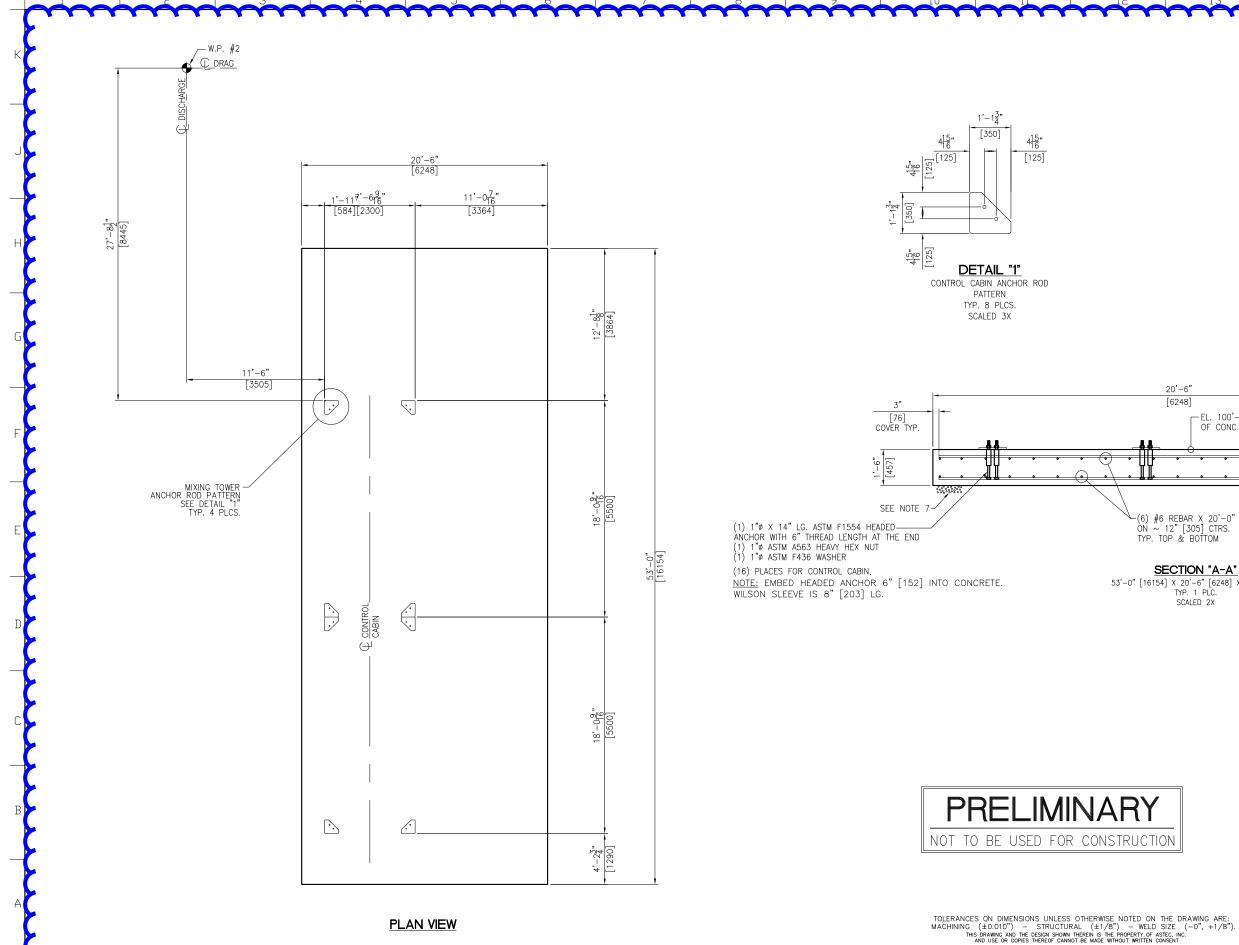

NOTES:

- 1. FOUNDATIONS SHOWN HEREIN ARE DESIGNED FOR A MINIMUM SOIL BEARING PRESSURE OF 2,000 PSF. THE CUSTOMER IS RESPONSIBLE TO ENSURE THAT THE ALLOWABLE SOIL BEARING PRESSURE AT THE SITE EQUALS OR EXCEEDS THE DESIGN
- 2. CONCRETE: F'C = 4,000 P.S.I. @ 28 DAYS UNLESS NOTED OTHERWISE
- OTHERWISE


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- 5. 5. BENCHMARK ELEVATION 100'-0"[30480] TO BE ESTABLISHED
  © TOP OF FINISHED CONCRETE NEAR DRAG BASE FOUNDATION.
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  A FLATNESS TOLERANCE OF ±1/8" [3] OVER 10'-0" [3048] IS TO BE MAINTAINED FOR ALL CONCRETE SLAB SURFACES.

  PROVIDE 12" [305] MIN. OF A WELL DRAINING GRANULAR BASE BELOW CONCRETE FOOTING.

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- AREA (DETERMINED BY LOCAL TOPOGRAPHY) TO PROVIDE FOR DRAINAGE AWAY FROM EQUIPMENT.
- 9. FOUNDATION DRAWINGS SHOWN HEREIN HAVE BEEN DESIGNED FOR THE HAMILTON, BERMUDA SITE (W.O. 24-090) AND SHALL BE VOIDED FOR USE AT ANY OTHER SITE.
- 10.DO NOT SCALE. THIS DRAWING MAY BE A REDUCED COPY.



53'-0" [16154] X 20'-6" [6248] X 18" [457]

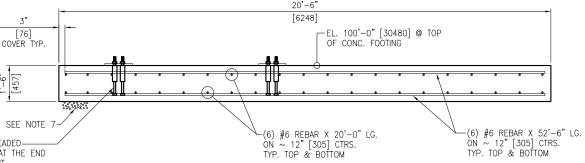REBAR CONVERSION CHART							
	IMPERIAL BAR DIA.	METRIC BAR DIA					
#4	.500	12.7					
#6	.75	19					
#8	1"	25.4					
#9	1.125"	28.5					

REVISION APPR BY DATE 4101 JEROME AVENUE CHATTANOOGA, TN 37407

USTOMER BERMUDA MINISTRY OF PUBLIC WORKS (HAMILTON, HM 12)

FOUNDATION PLAN, SECTIONS & DETAILS

ACHINE CONTROL CABIN

DWN GREG WILLIAMS CHKD